

### SHEET LIST

001 AU001 R001 S001 U001-U011 U012-U015 U016-U019

COVER SHEET PAY ITEMS AND NOTES (WATERLINE) STORM WATER MANAGEMENT PLAN SURVEY DATA SHEET 12" WATERLINE PLAN & PROFILE WATERLINE CROSSING PLAN & PROFILE SANITARY SEWER PLAN & PROFILE

#### CITY OF LAWTON STANDARD DRAWINGS

WATER SYSTEM 1 WATER SYSTEM 2 SANITARY SEWER SYSTEM 1 SANITARY SEWER SYSTEM 2

MAYOR:	DATE
CITY MANAGER:	DATE
CITY ENGINEER:	DATE
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Of LAHON A	10/6/2021
NICHOLAS A. DAVIDSON, OKLA. REG. ENGR. 24562	DATE

#### WATERLINE CONSTRUCTION PAY ITEMS CITY OF LAWTON, OKLAHOMA W. GORE BOULEVARD RECONSTRUCTION - 82ND ST. TO 67TH ST.

ITEM NO.	CITY OF LAWTON SPEC. NO	DESCRIPTION	UNIT	QUANTITY
1		CONSTRUCTION AS-BUILT 1,2	LS	1.00
2	0201/0205	4" PVC C900 DR14 (TRENCHING) 3	LF	88.00
3	0201/0205	8" PVC C900 DR14 (TRENCHING) 3	LF	100.00
4	0201/0205	12" PVC C900 DR14 (TRENCHING) 3	LF	3,276.00
5	0201/0205	4" PVC C900 DR14 (HORIZONTAL DRILLING) 3	LF	270.00
6	0201/0205	8" PVC C900 DR14 (HORIZONTAL DRILLING) 3	LF	215.00
7	0201/0205	12" PVC C900 DR14 (HORIZONTAL DRILLING) 3	LF	1,925.00
8	0201/0205	FITTINGS	LB	11,539.00
9	0201/0205	4" RESILIENT-SEATED GATE VALVE	EA	4.00
10	0201/0205	8" RESILIENT-SEATED GATE VALVE	EA	3.00
11	0201/0205	12" RESILIENT-SEATED GATE VALVE	EA	16.00
12	0201/0205	FIRE HYDRANT W/ 6" GATE VALVE	ΕA	14.00
13	0201/0205	WATER METER RECONNECTION 1-1/2"	ΕA	13.00
14		EROSION CONTROL MEASURES 6	LS	1.00
15		MOBILIZATION	LS	1.00

#### SANITARY SEWER LINE CONSTRUCTION PAY ITEMS CITY OF LAWTON, OKLAHOMA W. GORE BOULEVARD RECONSTRUCTION - 82ND ST. TO 67TH ST.

ITEM NO.	CITY OF LAWTON SPEC. NO	DESCRIPTION	UNIT	QUANTITY
16		CONSTRUCTION AS-BUILT 1,2	LS	1.00
17	0302/0318	8" SANITARY SEWER PIPE (PVC SDR35, D3034)	LF	451.00
18	0302/0318	8" SANITARY SEWER PIPE (PVC SDR35, D3034) (DIRECTIONALLY DRILLED)	LF	57.00
19	0302/0318	12" SANITARY SEWER PIPE (PVC SDR35, D3034)	LF	424.00
20	0302/0318	4' DIA STANDARD DEPTH MANHOLE	EΔ	7.00
21	0302/0318	4' DIA MANHOLE EXTRA DEPTH	VF	57.00
22	0302/0318	PIPE BURSTING	LF	344.00
23		REMOVE AND REPLACE ASPHALT PAVEMENT 4	SY	25.00
24		BYPASS PUMPING 5	LSUM	1.00

#### PAY ITEM NOTES:

- SPOT FLEVATIONS ON THE MAIN WATERLINE RELATIVE TO FINISHED GRADE SHALL BE SPOT ELEVATIONS ON THE MAIN WATERCINE RELATIVE TO TIMOTED GRADE GRADE DE PROVIDED AT EACH 100-FT INTERVAL, COMPLETE WITH STATION AND OFFSET. IN ADDITION, ALL VALVES, FITTINGS, FIRE HYDRANTS (TOP OF NUT) AND OTHER MAJOR APPURTENANT ITEMS SHALL BE SHOWN WITH THE PROPER DESCRIPTION, STATION, OFFSET, AND ELEVATION.
- 2. SPOT ELEVATIONS ON WATER METER CANS AND VAULTS SHALL BE SHOWN WITH THE PROPER DESCRIPTION (METER TYPE, METER SIZE, METER NUMBER, SERVICE MATERIAL, SERVICE SIZE), STATION, OFFSET, AND ELEVATION PER PLAN SURVEY CONTROL DATUM.
- 3. PRICE BID FOR THIS ITEM SHALL INCLUDE THE COST OF INSTALLATION OF 12 GUAGE TRACER WIRE BURIED WITH ALL PVC WATERLINE PIPE.
- QUANTITY INCLUDES THE REMOVAL AND REPLACEMENT OF CONCRETE CURB (AS REQUIRED)
- 5. BYPASS PUMPING OPERATIONS SHALL BE UTILIZED TO TEMPORARILY REROUTE SANITARY SEWER FLOWS AROUND SEVERAL WORK AREAS DURING PIPE BURSTING AND/OR PIPE ACCORDANCE WITH THE REQUIREMENTS OF SECTION 0300, PARAGRAPH 12 BYPASS PUMPING OF THE CITY'S TECHNICAL SPECIFICATIONS AND THE REQUIREMENTS OF THE BYPASS PUMPING SPECIAL PROVISION. THE COST OF BYPASS PUMPING SHALL INCLUDE THE FURNISHING OF ALL MATERIALS, LABOR, EQUIPMENT, POWER, AND , MAINTENANCE REQUIRED TO DIVERT FLOWS AROUND THE WORK AREAS FOR THE DURATION OF THE PIPE BURSTING OR PIPE REPLACEMENT OPERATIONS NO ADDITIONAL PAYMENT SHALL BE MADE
- TEMPORARY EROSION AND SEDIMENT CONTROL SHALL CONSIST OF ALL REQUIRED MEASURES TO MINIMIZE POLLUTION TO STREAMS, DITCHES, STORM SEWERS AND PRIVATE PROPERTIES. SUCH MEASURES MAY INCLUDE BERMS, DIKES, SILT FENCE, FIBER LOGS, SEDIMENT FILTERS, MULCHES AND GRASSES



#### GENERAL CONSTRUCTION NOTES

PAY ITEMS LISTED IN THE BID SCHEDULE ARE THE ONLY PAY ITEMS FOR THE PROJECT. ANY OTHER ITEMS NECESSARY FOR A COMPLETE PROJECT, BUT NOT SHOWN IN THE BID SCHEDULE SHALL BE CONSIDERED AN INCIDENTAL ITEM AND IT'S COST TO BE INCLUDED IN OTHER ITEMS.

THE CONTRACTOR SHALL VERIFY ALL UTILITY LOCATIONS PRIOR TO BIDDING PROJECT. ALL UTILITY LOCATIONS SHOWN ARE APPROXIMATE, EXCEPT AS NOTED.

ANY CONTRACTOR-CAUSED DAMAGE TO UTILITY AND/OR SERVICE LINES, SHOWN OR NOT SHOWN ON THE PLANS, SHALL BE REPAIRED OR REPLACED AT NO COST TO THE CITY OF LAWTON AND SHALL BE ACCOMPLISHED BY THE CONTRACTOR, SUBCONTRACTOR OR LICENSED PLUMBER AS APPROVED BY THE CITY ENGINEER.

ALL WATER MAINS OR SERVICE LINES THAT ARE TO BE ABANDONED SHALL BE PHYSICALLY SEVERED AS CLOSE TO THE REMAINING WATERLINE AS POSSIBLE AND A MECHANICAL JOINT CAP OR PLUG INSTALLED AS DIRECTED BY THE CITY ENGINEER

THE CONTRACTOR SHALL BE RESPONSIBLE FOR NOTIFYING ALL UTILITY COMPANIES PRIOR TO COMMENCING WORK IN THE PROJECT AREA. LIKEWISE, THE CONTRACTOR IS RESPONSIBLE FOR COORDINATING HIS WORK AND THAT OF THE INVOLVED UTILITIES IN THE PROJECT AREA.

THE CONTRACTOR SHALL BE RESPONSIBLE FOR FURNISHING ALL LABOR, MATERIAL; EQUIPMENT AND INCIDENTAL ITEMS NEEDED TO PROVIDE ADEQUATE CONSTRUCTION SIGNING, BARRICADES, TRAFFIC CONTROL DEVICES AND OTHER RELATED ITEMS FOR THE PROJECT AREA, DURING THE CONSTRUCTION PERIOD. THIS WORK IS TO BE CONSIDERED AN INCIDENTAL ITEM AND THE COST OF THIS ITEM IS TO BE INCLUDED IN OTHER PAY ITEMS.

THE CONTRACTOR SHALL NOTIFY THE L.P.D. CHIEF, L.F.D. CHIEF, CITY ENGINEER, PUBLIC WORKS DIRECTOR AND ALL PRIVATELY OWNED AMBULANCE COMPANIES 24 HOURS IN ADVANCE OF WHEN TRAFFIC IS TO BE RESTRICTED ON ANY STREET. IF AN EMERGENCY ARISES, THE CONTRACTOR SHALL IMMEDIATELY NOTIFY ALL PARTIES PREVIOUSLY NOTED.

THE CONTRACTOR SHALL PROVIDE REASONABLE ACCESS TO RESIDENTIAL, COMMERCIAL AND PUBLIC PROPERTIES IN THE PROJECT AREA. DURING CONSTRUCTION, TRAFFIC MAY BE RESTRICTED TO LOCAL TRAFFIC ONLY WITH APPROVAL OF THE CITY ENGINEER.

THE CONTRACTOR SHALL CAREFULLY REMOVE, STORE AND REINSTALL ALL CITY-OWNED SIGNS WHOSE REMOVAL IS REQUIRED BY HIS CONSTRUCTION WORK IN THE PROJECT AREA. IT SHALL BE THE CONTRACTOR'S RESPONSIBILITY TO ARRANGE FOR THE CITY TO INSPECT ALL SIGNS SCHEDULED FOR REMOVAL PRIOR TO THEIR REMOVAL ONCE SAID SIGNS HAVE BEEN REMOVED. IT WILL BE ASSUMED THAT THEY WERE IN GOOD CONDITION AT THE TIME OF REMOVAL. ANY SIGNS DAMAGED OR LOST BY THE CONTRACTOR SHALL BE REPLACED AT NO COST TO THE CITY. MATERIALS SHALL BE APPROVED BY THE CITY ENGINEER.

ALL POST-MOUNTED SIGNS SHALL BE RESET IN CONCRETE AND AT THE PROPER HEIGHT AND LOCATION (CITY TO PROVIDE LOCATION).

ALL SIDEWALK AND PAVED DRIVEWAY REMOVALS SHALL BE BOUNDED BY JOINTS OR SAWCUTS.

THE CONTRACTOR SHALL BE RESPONSIBLE FOR COORDINATING ALL DRIVEWAY CLOSINGS WITH THE RESPECTIVE PROPERTY OWNERS AND TENANTS IF PROPERTY IS RENTED

EXISTING CONCRETE DRIVES WILL BE REPLACED WITH 6" MIN. NON-REINFORCED CLASS 3500 PSI H.E.S. CONCRETE AS SPECIFIED ON THE PLAN DOCUMENTS.

PROPERTY OWNERS WILL BE NOTIFIED BY THE CITY, PRIOR TO CONSTRUCTION, THAT IT WILL BE THE OWNER'S RESPONSIBILITY TO REMOVE OR RELOCATE FENCES, TREES, SHRUBS OR OTHER PROPERTY WHICH THEY INTEND TO KEEP. IF THE ITEMS ARE NOT REMOVED AT THE TIME OF PROPERTY WHICH THEY INTERD TO KEEP. IF THE ITEMS ARE NOT REINDED AT THE TIME OF CONSTRUCTION AND ARE IN THE WAY OF CONSTRUCTION, THE CONTRACTOR SHALL REMOVE AND DISPOSE OF THE ITEMS AS DIRECTED BY THE CITY ENGINEER. FENCES SHALL BE REINSTALLED AT THE CONTRACTOR UNIT PRICE FOR FENCES AS DIRECTED BY THE CITY ENGINEER.

THE CONTRACTOR SHALL VERIFY ALL DIMENSIONS AND ELEVATIONS PRIOR TO THE START OF

ANY SURPLUS EXCAVATION SHALL BECOME THE PROPERTY OF THE CONTRACTOR, AND DISPOSAL SHALL BE THE CONTRACTOR'S RESPONSIBILITY AT NO ADDITIONAL COST

THE CONTRACTOR SHALL BE RESPONSIBLE FOR ALL SURVEYING AND CONSTRUCTION STAKING FOR THE PROJECT.

ALL GRADING AND SURFACING SHALL BE IN ACCORDANCE WITH THE PLAN SHEETS AND OKLAHOMA DEPARTMENT OF TRANSPORTATION STANDARD SPECIFICATIONS FOR HIGHWAY CONSTRUCTION.

THE CONTRACTOR SHALL REMOVE AND STOCKPILE ALL SALVAGED TOPSOIL TO BE USED LATER AS BACKFILL BEHIND CURBS AND DRIVES. THIS IS NOT A PAY ITEM, BUT COST OF SAME IS TO BE INCLUDED IN OTHER ITEMS OF WORK

THE CONTRACTOR SHALL LEVEL ALL DISTURBED AREAS WITH TOPSOIL AND HAND RAKE TO A UNIFORM APPEARANCE. COST SHALL BE INCLUDED IN THE PRICE BID FOR OTHER ITEMS

CAUTION: FOR UNDERGROUND UTILITY LOCATIONS, CONTACT 1-800-522-6543 PRIOR TO EXCAVATION

THE SPECIFICATIONS WHICH GOVERN THE MATERIALS TO BE FURNISHED AND THE WORK TO BE PERFORMED UNDER THIS CONTRACT ARE THE TECHNICAL SPECIFICATIONS (LATEST EDITION) SO PREPARED BY THE ENGINEERING DIVISION, PUBLIC WORKS DEPARTMENT, CITY OF LAWTON.

IN ADDITION THE OKLAHOMA DEPARTMENT OF TRANSPORATION STANDARD SPECIFICATIONS OF HIGHWAY CONSTRUCTION ARE, BY REFERENCE, HEREBY MADE A PART OF THE CONTRACT. IN CASE OF CONFLICT BETWEEN THE CITY'S TECHNICAL SPECIFICATION AND THE ODOT STANDARD SPECIFICATIONS, THE CITY'S TECHNICAL SPECIFICAITONS SHALL GOVERN EXCEPT AS MODIFIED BY THE PROJECT'S CONTRACT DOCUMENTS.

#### GENERAL CONSTRUCTION NOTES FOR WATERLINES:

ALL EXCAVATION WITHIN 2 FEET OF PAVEMENT SHALL BE BACKFILLED AND COMPACTED TO 95% STANDARD PROCTOR DENSITY WITH LIMESTONE SCREENINGS.

UNLESS NOTED NEW  $1\!\!\!/_2$  INCH SERVICE LINES SHALL BE INSTALLED FROM NEW MAIN TO METER BOX ACCORDING TO STANDARD DETAIL SHEET INCLUDING ANGLE VALVE ON ALL METERS LOCATED ADJACENT TO NEW MAIN. FOR SERVICES LOCATED ON THE OPPOSITE SIDE OF THE STREET FROM THE MAIN, THE EXISTING SERVICE LINE SHALL BE UTILIZED AND CONNECTED TO THE NEW MAIN. CITY OF LAWTON TECHNICAL SPECIFICATION DOES NOT ALLOW THE SPLICING OF SERVICE LINES, SO A NEW FULL LENGTH SERVICE LINE MAY BE REQUIRE IN SOME APPLICATIONS

ADDITIONAL DRIVEWAY REPAIR MAY BE ADDED AS DIRECTED BY THE PROJECT ENGINEER. FOR DRIVEWAY REPAIRS, SEE DETAILS.

SIDEWALK REPAIR SHALL BE PAID UNDER PAY ITEM FOR CONCRETE DRIVE REPAIR

CONTRACTOR SHALL BORE UNDER TREES IN - LIEU OF TREE REMOVAL AT LOCATIONS DIRECTED BY THE PROJECT ENGINEER. COST SHALL BE INCLUDED IN THE PRICE BID FOR BORE W/O CASING.

ALL WATER MAIN VALVES SHALL BE OPERATED ONLY BY CITY OF LAWTON PUBLIC WORKS. PERSONNEL. THE CONTRACTOR SHALL NOTIFY THE PUBLIC WORKS/ENGINEERING DEPARTMENT A MINIMUM OF 96 HOURS IN ADVANCE OF REQUIRED VALVE OPERATIONS.

THE CONTRACTOR SHALL COORDINATE TIE-INS OF NEW WATERLINES TO EXISTING LINES WITH THE CITY OF LAWTON PUBLIC WORKS/ENGINEERING DIRECTOR AND THE CITY OF LAWTON FIRE DEPARTMENT CHIEF

EXISTING FIRE HYDRANTS AND RELATED VALVES SHALL BE REMOVED AND SALVAGED IN GOOD CONDITION AND DELIVERED TO THE CITY OF LAWTON PUBLIC WORKS/ENGINEERING MAINTENANCE YARD LOCATED AT 2100 SW 6TH STREET DURING NORMAL WORKING HOURS AS DIRECTED BY THE ENGINEER. COSTS TO BE INCLUDED WITH PRICE BID FOR OTHER ITEMS.

THE CONTRACTOR SHALL REMOVE VALVE BOXES FROM VALVES TO BE ABANDONED IN AREAS NOT PAVED AND BACKFILL HOLE WITH SUITABLE MATERIAL. IN PAVED AREAS WHERE THE VALVE BOX CANNOT BE EASILY REMOVED, THE CONTRACTOR SHALL REMOVE THE LID AND FILL THE BOX WITH CONCRETE. SALVAGED VALVE BOXES AND LIDS SHALL BE DELIVERED BY THE CONTRACTOR TO THE CITY OF LAWTON PUBLIC WORKS/ENGINEERING YARD.

ALL METERS TO BE RELOCATED SHALL BE PLACED AS CLOSE TO THE PROPERTY LINE AS PRACTICAL, OR AS DIRECTED BY THE PROJECT ENGINEER. THE QUANTITIES SHOWN IN THE SUMMARY OF BID QUANTITIES FOR METER RELOCATION AND 1" SERVICE LINE ARE FOR BIDDING PURPOSES ONLY. THE ACTUAL QUANTITIES REQUIRED WILL BE DETERMINED DURING CONSTRUCTION.

ALL LINES AND FITTINGS SHALL BE THRUST BLOCKED IN ACCORDANCE WITH CITY OF LAWTON

THE CONTRACTOR SHALL PLACE A 4 INCH THICK LAYER OF TOPSOIL ON ALL AREAS TO BE GRASSED. THE PRICE OF SALVAGING, IMPORTING, AND PLACING TOPSOIL SHALL BE INCLUDED IN THE UNIT PRICE FOR GRASSING.

MINIMUM COVER FOR THE WATERLINE INSTALLATION SHALL BE FORTY-TWO INCHES (42") FROM THE TOP OF GROUND TO THE TOP OF THE PIPE UNLESS SPECIFIED OTHERWISE

PVC (AWWA C900 DR18) OR POLYBOND LINED D.I. (CLASS 51) SANITARY SEWER PIPE MAY BE REQUIRED AT LOCATIONS WHERE THE MINIMUM SPACING REQUIREMENT WITH WATER MAINS CANNOT BE ACHIEVED. THE CONTRACTOR SHALL FURNISH AND INSTALL (COMPLETE) THE REQUIRED TYPE AND LENGTH OF PIPE AT LOCATIONS AS DIRECTED BY THE ENGINEER. MATERIALS AND METHODS FOR TRENCHING/BACKFILL SHALL FOLLOW SPECIFICATIONS AS SET IN SECTION 0300 SEWERLINE CONSTRUCTION. COST SHALL BE INCLUDED IN THE PRICE BID FOR SANITARY SEWER PIPE (PVC C900 DR18 OR POLYBOND D.I. PIPE CLASS 51)

ALL LINES WHICH ARE TO REMAIN IN SERVICE SHALL BE COMPLETELY DISCONNECTED FROM ABANDONED LINES BY PLUGGING THE LIVE LINE CROSS OR TEE WITH AN M.J. PLUG (MEGALUG OR EQUAL). LEAD JOINT FITTINGS SHALL BE COMPLETELY REMOVED AND A NEW LINE SEGMENT SLEEVED IN. THE END OF ABANDONED PIPE SHALL BE SEALED WITH NON-SHRINK GROUT. FITTINGS SHALL BE PAID AT THE CONTRACT BID PRICE AND ALL OTHER COSTS SHALL BE CONSIDERED INCIDENTAL

ALL MECHANICAL FITTINGS SHALL BE INSTALLED WITH MJ FITTINGS (MEGALUG OR EQUAL).

WATER MAINS SHALL BE CAPPED IF REQUIRED FOR TESTING, PRIOR TO TIE-INS BEING MADE.

FENCES AND MAILBOXES SHALL BE REMOVED AND REINSTALLED BY THE CONTRACTOR AS DIRECTED BY THE ENGINEER.

ALL SERVICE LINE TAPS SHALL BE 11/2 INCHES AND SERVICE LINES SHALL BE 11/2 INCH IN SIZE

THE CONTRACTOR SHALL BE RESPONSIBLE FOR DOOR-TO-DOOR NOTIFICATION OF ALL AFFECTED PERSONS PRIOR TO SHUTTING OFF A WATER MAIN.

ALL NEW FIRE HYDRANTS SHALL BE COVERED WITH BLACK PLASTIC WRAP UNTIL SUCH TIME AS THEY ARE OPERATIONAL

ALL BACKFILL FOR WATERLINE TRENCHING SHALL BE WATER JETTED AFTER THE CONNECTION OF ALL SERVICE LINES. COST TO BE INCLUDED IN THE UNIT PRICE FOR PIPE, OR AS INCIDENTALS.

ALL TAPS SHALL BE ACCOMPLISHED BY THE CONTRACTOR. COST SHALL BE INCLUDED IN THE PRICE BID FOR SERVICE TAPS OR TAPPING SADDLE AND VALVE.

Design	ND	2/2021
Drawn	ND	2/2021
Checked	MA	2/2021
Approved		
Squad	Dewberry	

SUMMARY OF PAY ITEMS AND NOTES (WATERLINE AND SEWERLINE) J/P# 19144(04)

# STORM WATER MANAGEMENT PLAN

## SITE DESCRIPTION

PROJECT LIMITS: W GORE BLVD, 82ND ST. TO 67TH ST. IN COMANCHE COUNTY

PROJECT DESCRIPTION: WATERLINE AND SEWERLINE RECONSTRUCTION

SUGGESTED SEQUENCE OF EROSION CONTROL ACTIVITIES: \_ PRIOR TO INITIATING SOIL DISTURBING ACTIVITIES, THE CONTRACTOR WILL INSTALL ALL PERIMETER TEMPORARY SEDIMENT CONTROLS SPECIFIED. STRIP, STOCKPILE AND STABILIZE TOPSOIL. CLEAR AND GRUB ONLY IN NECESSARY AREAS, PRESERVING AS MUCH NATIVE VEGETATION AS POSSIBLE. INSTALL, MAINTAIN AND/OR MOVE TEMPORARY SEDIMENT ITEMS WITH CONSTRUCTION OPERATIONS AS PRACTICAL. REPLACE SALVAGED TOPSOIL AND DEVICES WHEN AN ACCEPTABLE VEGETATIVE COVER (AT LEAST 70%) HAS BEEN ATTAINED. AS SITE CONDITIONS WARRANT, THE CONTRACTOR MAY CHOOSE TO MODIFY THE TYPE OR ARRANGEMENT OF SPECIFIED PRACTICES TO IMPROVE THEIR EFFECTIVENESS AS APPROVED BY THE ENGINEER. THE CONTRACTOR WILL MAINTAIN A LOG OF THE DATES OF MAJOR SOIL DISTURBANCE ACTIVITIES, AND ALSO THE DATES OF INSTALLATION OF EROSION CONTROL MEASURES

SOIL TYPE: FAT CLAYS

TOTAL AREA OF THE CONSTRUCTION SITE: 14.90 ACRES

ESTIMATED AREA TO BE DISTURBED: 2.00 ACRES

OFFSITE AREA TO BE DISTURBED: (FOR CONTRACTOR USE)

> TOTAL IMPERVIOUS AREA PRE-CONSTRUCTION: 5.13 ACRES

> TOTAL IMPERVIOUS AREA POST-CONSTRUCTION: 5.13 ACRES

POST-CONSTRUCTION RUNOFF COEFFICIENT OF THE SITE: 0.90

> LATITUDE & LONGITUDE OF CENTER OF PROJECT: <u>34°36' 32.15" N 98</u>°29' 0.00" W

#### PROJECT WILL DISCHARGE TO:

	NAME OF	RECEIVING WAT	ERS: WEST BRANCH WOLF CREEK
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ENSITIVE WATERS OR WATERSHEDS:	YES	NOX	
303(d) IMPAIRED WATERS:	YES	NOX	
IF YES, LIST IMPAIRMENT: _			
LOCATED IN A TMDL:	YES	NOX	
LAKE THUNDERBIRD TMDL:	YES	NOX	
MS4 ENTITY	YES X	NO	

### IF YES, LOCATION: \_\_CITY OF LAWTON

NOTE: THIS SHEET SHOULD BE USED IN CONJUNCTION WITH A DRAINAGE MAP THAT ILLUSTRATES THE DRAINAGE PATTERNS/PATHWAYS AND RECEIVING WATERS FOR THIS PROJECT. THIS SHEET SHOULD ALSO BE USED WITH THE EROSION CONTROL SUMMARIES, PAY ITEMS, & NOTES,

## **EROSION AND SEDIMENT CONTROLS**

#### SOIL STABILIZATION PRACTICES:

TEMPORARY SEEDING

- PERMANENT SODDING, SPRIGGING OR SEEDING
- VEGETATIVE MULCHING
- SOIL RETENTION BLANKET

 $\underline{X}$  PRESERVATION OF EXISTING VEGETATION

NOTE: TEMPORARY EROSION CONTROL METHODS MUST BE USED ON ALL DISTURBED AREAS WHERE CONSTRUCTION ACTIVITIES HAVE CEASED FOR OVER 14 DAYS. METHODS USED WILL BE AS SHOWN ON PLANS, OR AS DIRECTED BY THE ENGINEER.

#### STRUCTURAL PRACTICES:

	STABILIZED CONSTRUCTION EXIT
<u>X</u>	_ TEMPORARY SILT FENCE
<u>X</u>	_ TEMPORARY SILT DIKES
<u>X</u>	_ TEMPORARY FIBER LOG
	DIVERSION, INTERCEPTOR OR PERIMETER DIKES
	DIVERSION, INTERCEPTOR OR PERIMETER SWALES
	ROCK FILTER DAMS
	TEMPORARY SLOPE DRAIN
	PAVED DITCH W/ DITCH LINER PROTECTION
	TEMPORARY DIVERSION CHANNELS
	_ TEMPORARY SEDIMENT BASINS
	_ TEMPORARY SEDIMENT TRAPS
<u>X</u>	_ TEMPORARY SEDIMENT FILTERS
<u>X</u>	_ TEMPORARY SEDIMENT REMOVAL
	_ RIP RAP
<u>X</u>	_ INLET SEDIMENT FILTER
	TEMPORARY BRUSH SEDIMENT BARRIERS
	SANDBAG BERMS

TEMPORARY STREAM CROSSINGS

#### OFFSITE VEHICLE TRACKING:

 $\underline{X}$  HAUL ROADS DAMPENED FOR DUST CONTROL

- $\underline{X}$  loaded haul trucks to be covered with tarpaulin
- X EXCESS DIRT ON ROAD REMOVED DAILY

#### NOTES:

TEMPORARY EROSION AND SEDIMENT CONTROL SHALL CONSIST OF ALL REQUIRED MEASURES TO MINIMIZE POLLUTION TO STREAMS, DITCHES, STORM SEWERS AND PRIVATE PROPERTIES, SUCH MEASURES MAY INCLUDE BERMS, DIKES, SILT FENCE, FIBER LOGS, SEDIMENT FILTERS, MULCHES AND GRASSES.

### THE CONTRACTOR SHALL ALSO BE RESPONSIBLE FOR THE FOLLOWING:

MAINTENANCE AND INSPECTION: ALL EROSION AND SEDIMENT CONTROLS WILL BE MAINTAINED IN GOOD WORKING ORDER FROM THE BEGINNING OF CONSTRUCTION UNTIL AN ACCEPTABLE VEGETATIVE COVER IS ESTABLISHED. INSPECTION BY THE CONTRACTOR AND ANY NECESSARY REPAIRS SHALL BE PERFORMED ONCE EVERY 7 CALENDAR DAYS AND WITHIN 24 HOURS AFTER ANY STORM EVENT GREATER THAN 0.5 INCH AS RECORDED BY A NON-FREEZING RAIN GAUGE TO BE LOCATED ON SITE. POTENTIALLY ERODIBLE AREAS, DRAINAGEWAYS, MATERIAL STORAGE, STRUCTURAL DEVICES, CONSTRUCTION ENTRANCES AND EXITS ALONG WITH EROSION AND SEDIMENT CONTROL LOCATIONS ARE EXAMPLES OF SITES THAT NEED TO BE INSPECTED.

#### WASTE MATERIALS:

PROPER MANAGEMENT AND DISPOSAL OF CONSTRUCTION WASTE MATERIAL IS REQUIRED BY THE CONTRACTOR. MATERIALS INCLUDE STOCKPILES, SURPLUS, DEBRIS AND ALL OTHER BY-PRODUCTS FROM THE CONSTRUCTION PROCESS, PRACTICES INCLUDE DISPOSAL, PROPER MATERIALS HANDLING, SPILL PREVENTION AND CLEANUP MEASURES. CONTROLS AND PRACTICES SHALL MEET THE REQUIREMENTS OF ALL FEDERAL, STATE AND LOCAL AGENCIES.

#### HAZARDOUS MATERIALS:

PROPER MANAGEMENT AND DISPOSAL OF HAZARDOUS WASTE MATERIALS IS REQUIRED. THE CONTRACTOR IS RESPONSIBLE FOR FOLLOWING MANUFACTURER'S RECOMMENDATIONS, STATE AND FEDERAL REGULATIONS TO ENSURE CORRECT HANDLING, DISPOSAL, SPILL PREVENTION AND CLEANUP MEASURES. EXAMPLES INCLUDE BUT ARE NOT LIMITED TO: PAINTS, ACIDS, CLEANING SOLVENTS, CHEMICAL ADDITIVES, CONCRETE CURING COMPOUNDS AND CONTAMINATED SOILS.

#### GENERAL NOTES:

GENERAL NOTES: A STORM WATER POLLUTION PREVENTION PLAN (SWPPP) IS REQUIRED TO COMPLY WITH THE OKLAHOMA POLLUTION DISCHARGE ELIMINATION SYSTEM (OPDES) REGULATIONS. THIS PLAN IS INITIATED DURING THE DESIGN PHASE, CONFIRMED IN THE PRE-WORK MEETINGS AND AVAILABLE ON THE JOB SITE ALONG WITH COPIES OF THE NOTICE OF INTENT (NOI) FORM AND PERMIT CERTIFICATE THAT HAVE BEEN FILED WITH THE OKLAHOMA DEPARTMENT OF ENVIRONMENTAL QUALITY (ODEQ). THE PLAN MUST BE KEPT CURRENT WITH UP-TO-DATE AMENDMENTS DURING THE PROGRESSION OF THE PROJECT. ALL CONTRACTOR OFF.SITE OPERATIONS ASSOCIATED WITH THE PRO JECT MUST BE DOCI MENTED IN THE SWPPP J.E. BORROW PITS. WORK ROADS DISPOSAL THE PROGRESSION OF THE PROJECT. ALL CONTRACTOR OFF-SITE OPERATIONS ASSOCIATED WITH THE PROJECT MUST BE DOCUMENTED IN THE SWPPP, I.E., BORROW PITS, WORK ROADS, DISPOSAL SITES, ASPHALT/CONCRETE PLANTS, ETC. THE BASIC GOAL OF STORM WATER MANAGEMENT IS TO IMPROVE WATER QUALITY BY REDUCING POLLUTANTS IN STORM WATER DISCHARGES. RUNOFF FROM CONSTRUCTION SITES HAS A POTENTIAL FOR POLLUTION DUE TO EXPOSED SOILS AND THE PRESENCE OF HAZARDOUS MATERIALS USED IN THE CONSTRUCTION PROCESS. THE PREVENTION OF SOIL EROSION, CONTAINMENT OF HAZARDOUS MATERIALS AND/OR THE INTERCEPTION OF THESE POLLUTANTS BEFORE LEAVING THE CONSTRUCTION SITE ARE THE BEST PRACTICES FOR CONTROLLING STORM WATER POLLUTION.

### BE NOTED:

103.05	BONDING REQUIREMENTS
104.10	FINAL CLEANING UP
104.12	CONTRACTOR'S RESPONSIBILITY
104.13	ENVIRONMENTAL PROTECTION
106.08	STORAGE AND HANDLING OF MAT
107.01	LAWS, RULES AND REGULATIONS
107.20	STORM WATER MANAGEMENT
220	MANAGEMENT OF EROSION, SEDIN
221	TEMPORARY SEDIMENT CONTROL

IN ADDITION: "ODEQ GENERAL PERMIT (OKR10) FOR STORM WATER DISCHARGES FROM CONSTRUCTION ACTIVITIES WITHIN THE STATE OF OKLAHOMA." ODEQ, WATER QUALITY DIVISION, SEPTEMBER 13, 2017.

#### THE FOLLOWING SECTIONS OF THE 2019 ODOT STANDARD SPECIFICATIONS SHOULD

FOR WORK

TFRIAI TO BE OBSERVED

MENTATION AND STORM WATER POLLUTION PREVENTION AND CONTROL

Design			
Drawn			
Checked			
Approved			
Squad	Dewberry		


### **STORM WATER** MANAGEMENT PLAN


J/P# 19144(04) R001 W. GORE BLVD., 82ND, ST. TO 67TH ST.

### SURVEY CONTROL

OFF-SITE HORIZONTAL AND VERTICAL CONTROL - CITY OF LAWTON GPS NETWORK						
POINT	NORTHING	EASTING	ELEVATION	DESCRIPTION		
307	461936.419	1822997.703	1180.582	LAWTON GPS CONTROL		
	ON-SI	TE HORIZONTAL A	ND VERTICAL CON	ITROL		
POINT	NORTHING	EASTING	ELEVATION	DESCRIPTION		
LLS-101	464527.029	1820572.125	1190.52	#4 BAR W/ "LEMKE CONTROL" CAP		
LLS-102	464732.851	1823371,923	1177,35	#4 BAR W/ "LEMKE CONTROL" CAP		
LLS-104 464566.636 1824771.083 1156.64 #4 BAR W/ "LEMKE CONTROL" CAP						
LLS-105 464609.922 1825374.197 1151.91 #4 BAR W/ "LEMKE CONTROL" CAP						
LLS-110 464665.077 1820328.499 1183.26 #4 BAR W/ "LEMKE CONTROL" CAP						
LLS-111 464460.085 1825721.261 1153.49 #4 BAR W/ "LEMKE CONTROL" CAP						
LLS-112 464564.857 1821728.344 1170.01 #4 BAR W/ "LEMKE CONTROL" CAP						
HORIZONTAL DATUM: NAD(83) OKLAHOMA STATE PLANE, SOUTH ZONE.						
VERTICAL DATUM: NAVD(88)						




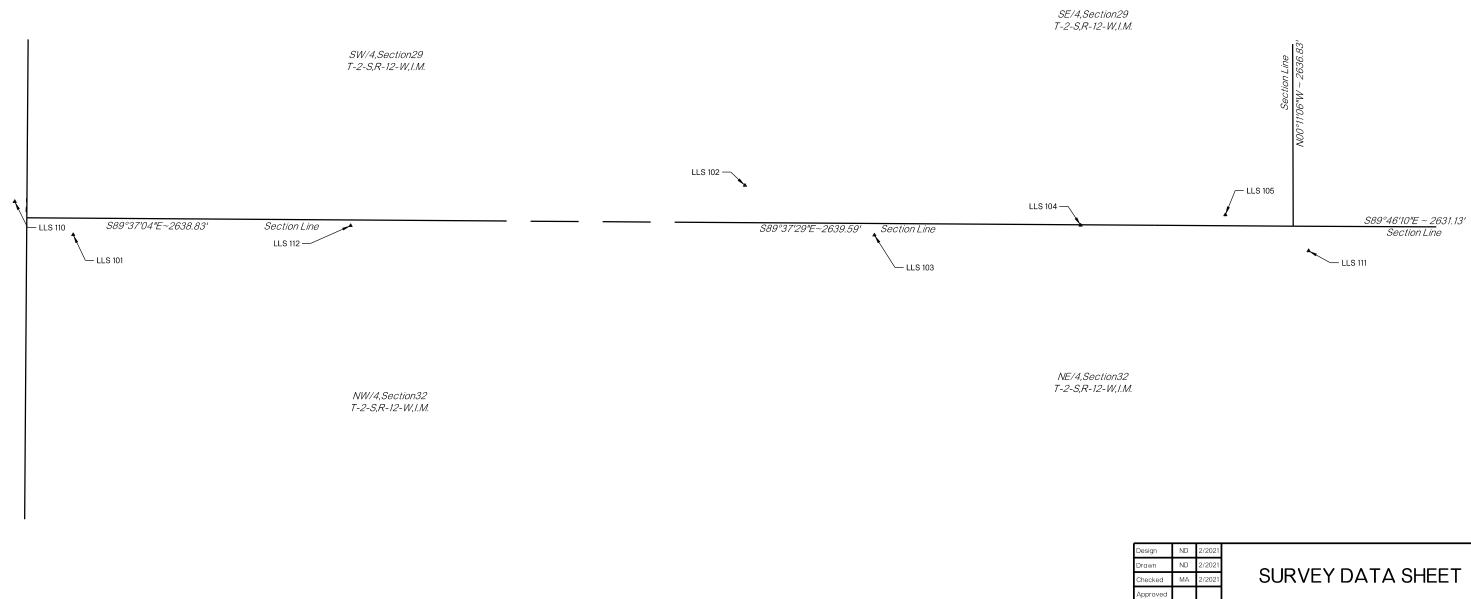


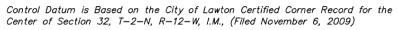



Design	ND	2/2021
Drawn	ND	2/2021
Checked	MA	2/2021
Approved		
Squad	Dewberry	


J/P# 19144(04) Sheet No. S001 Project No W. GORE BLVD., 82ND ST. TO 67TH ST.

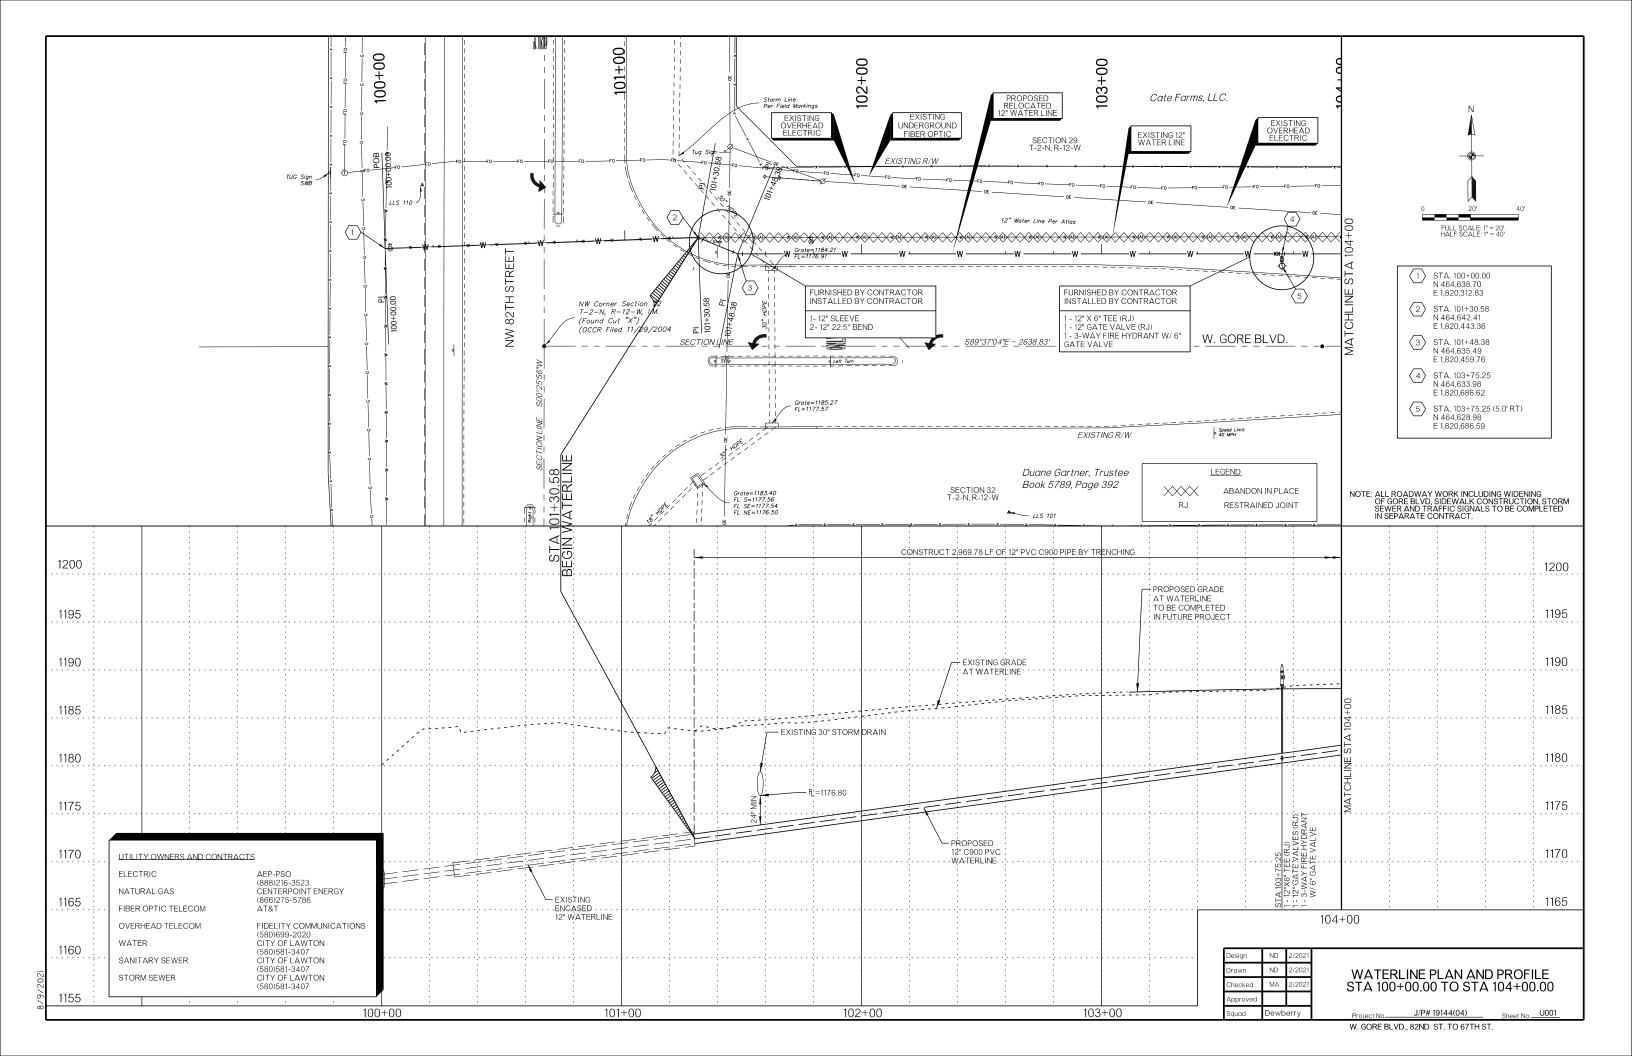


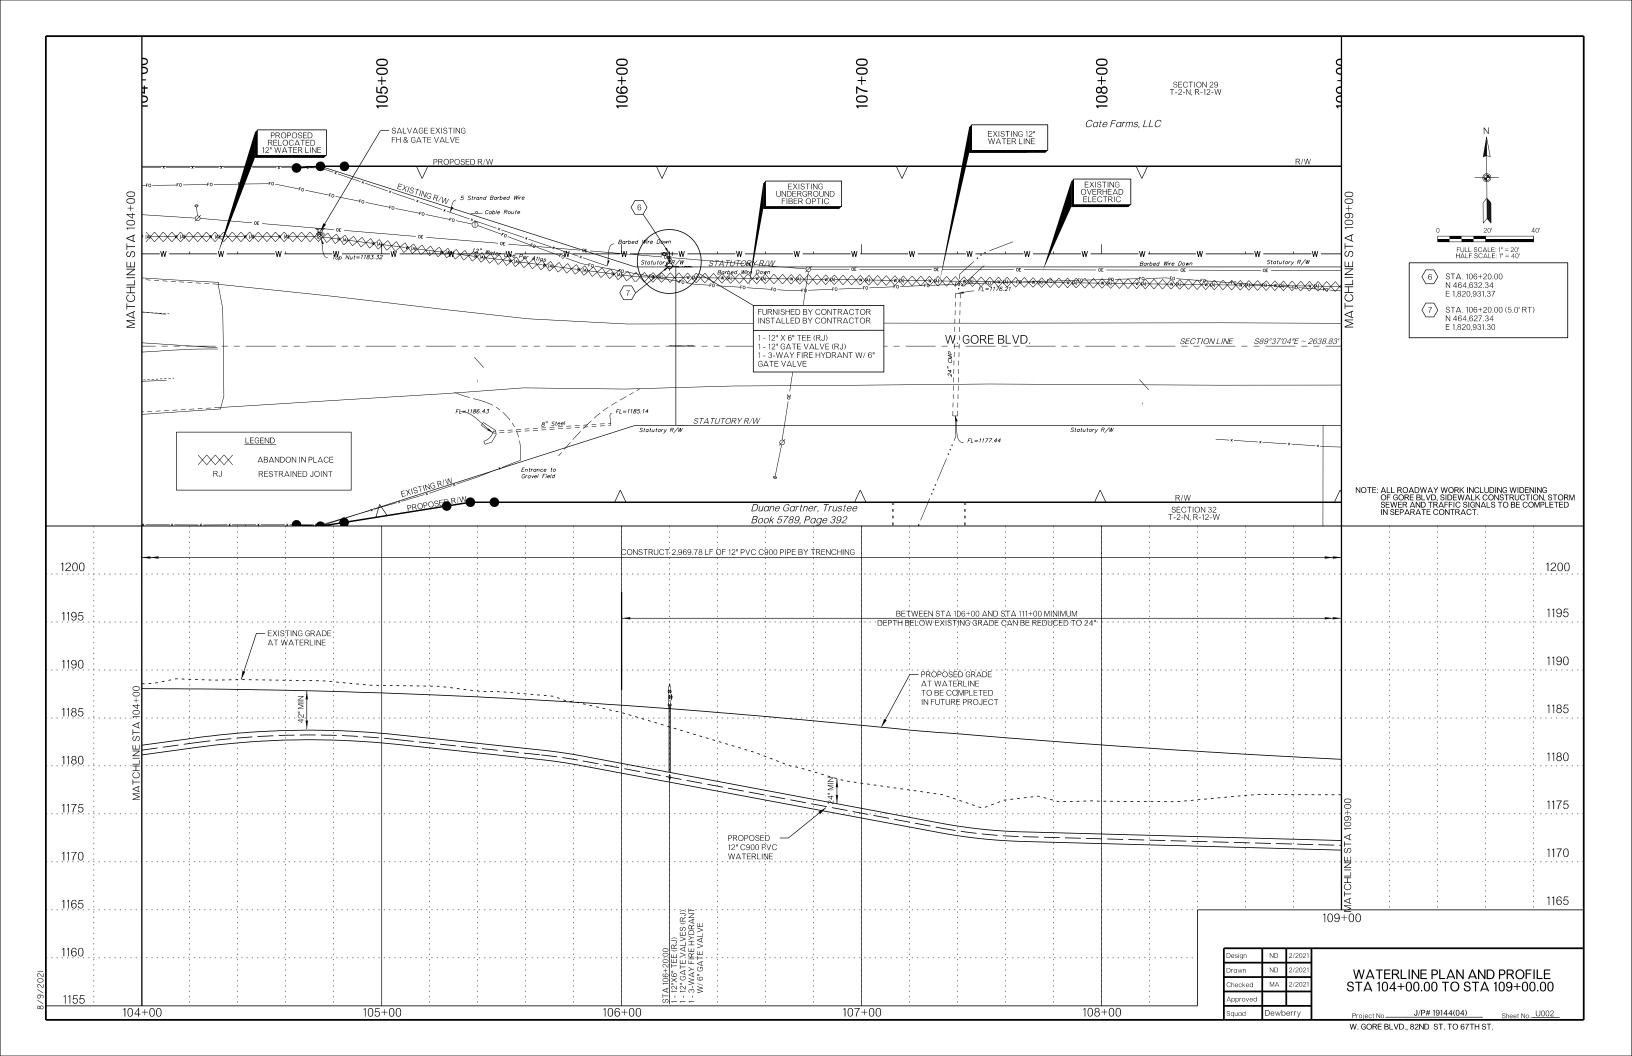


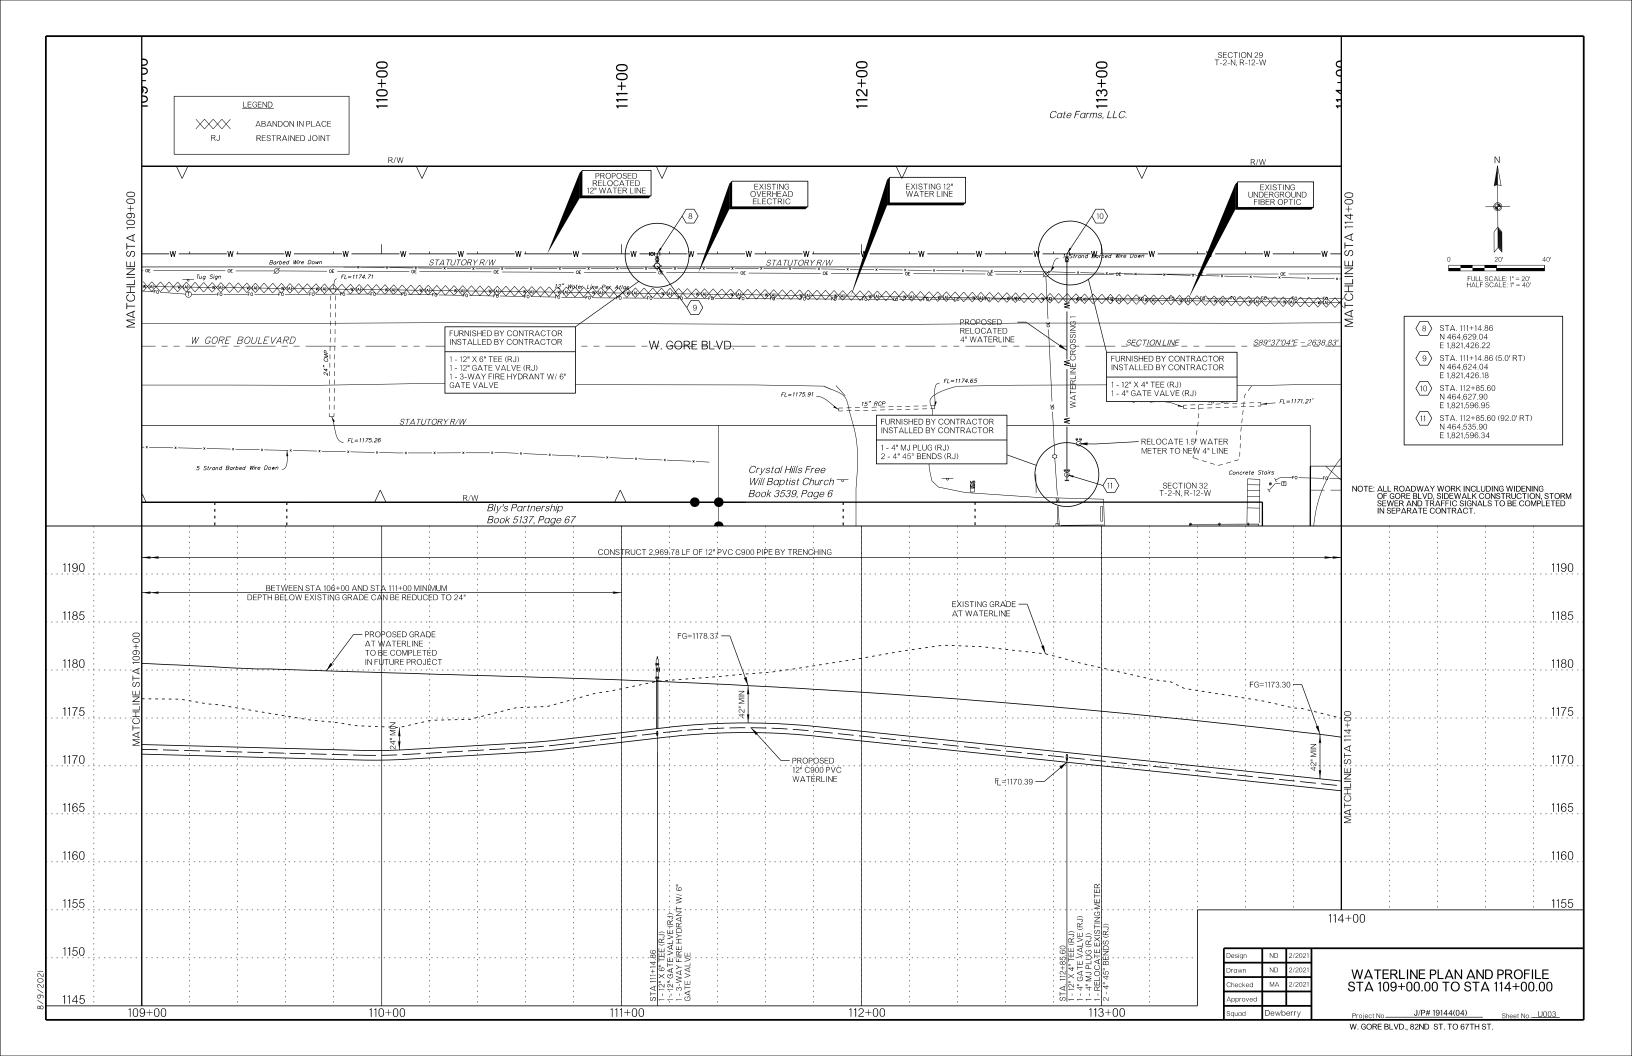


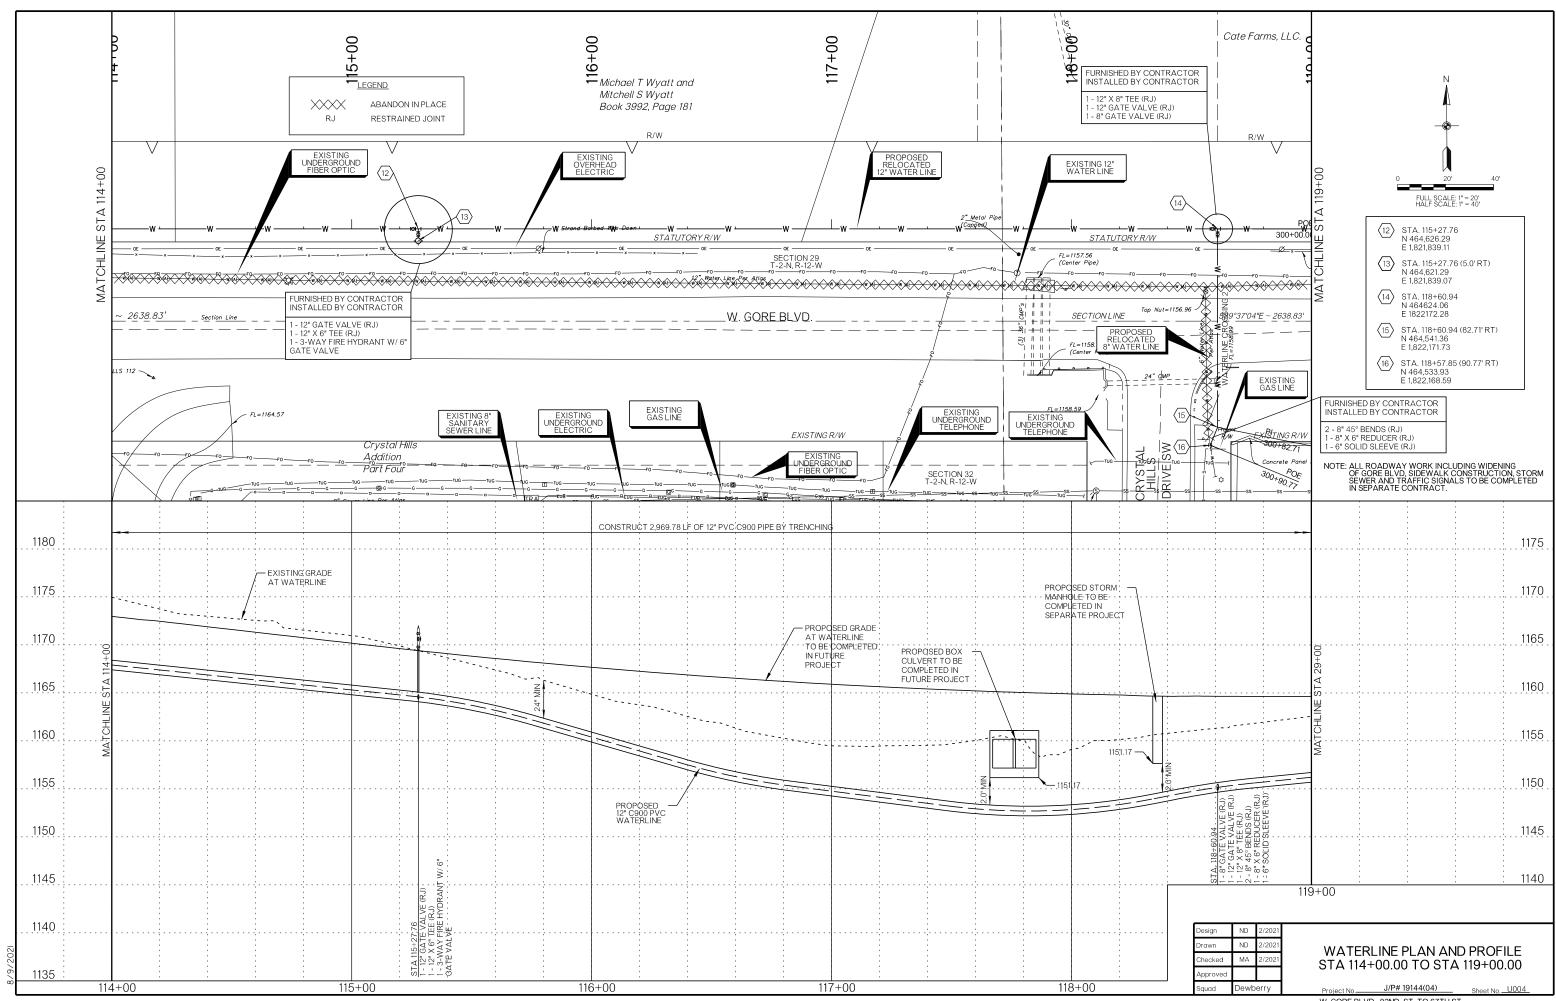


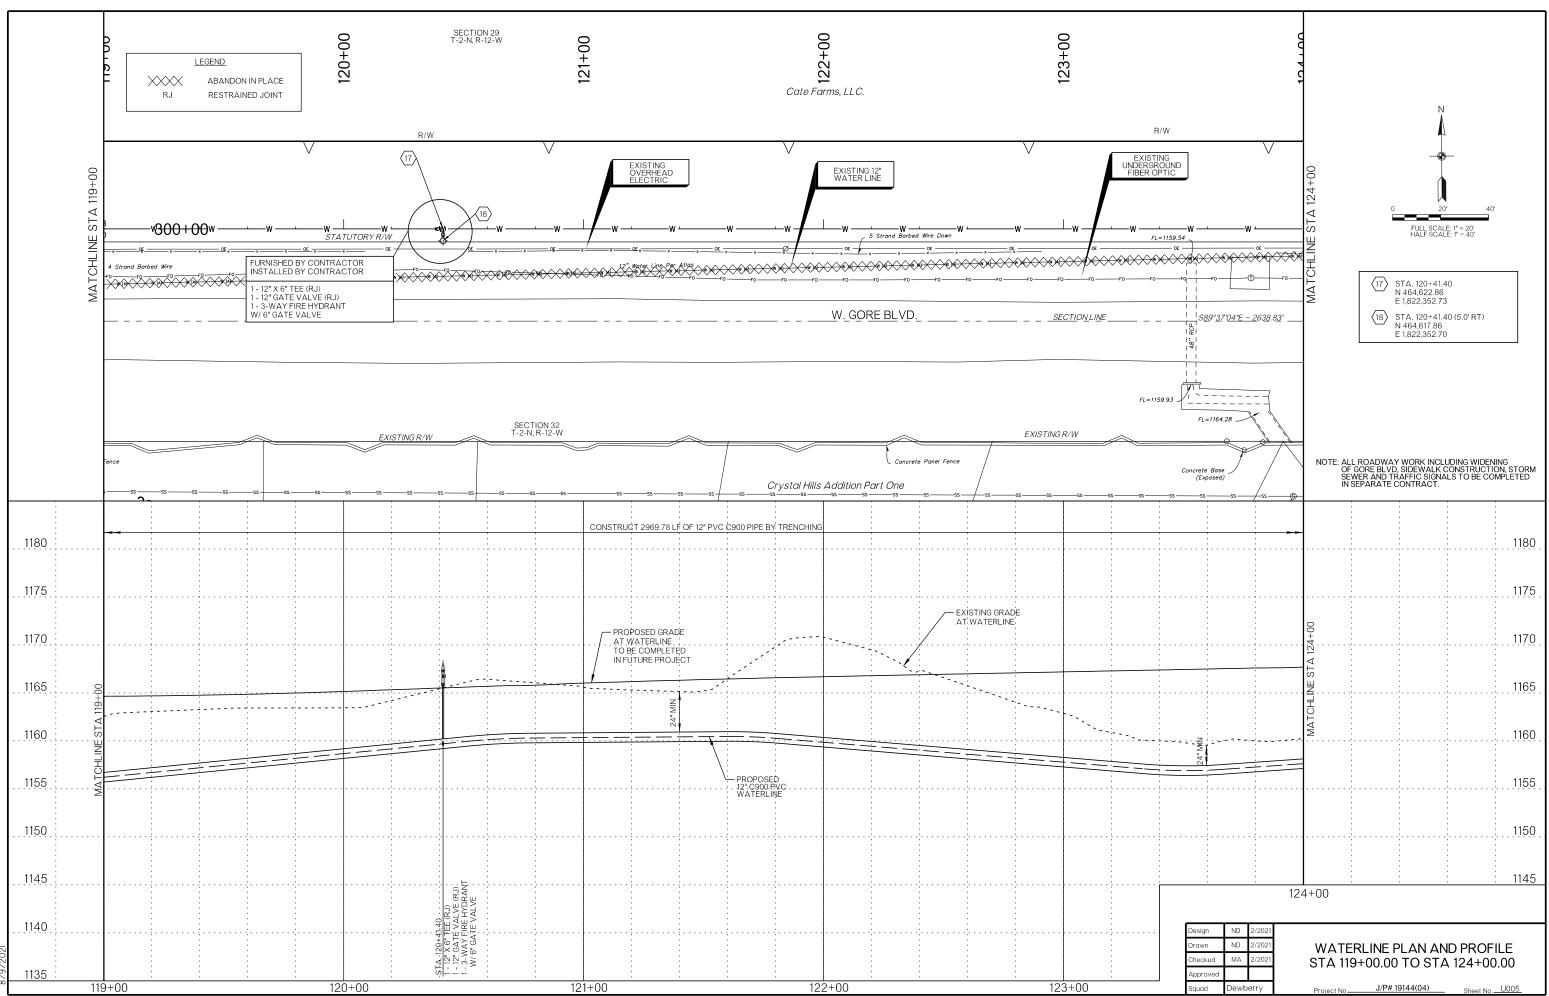


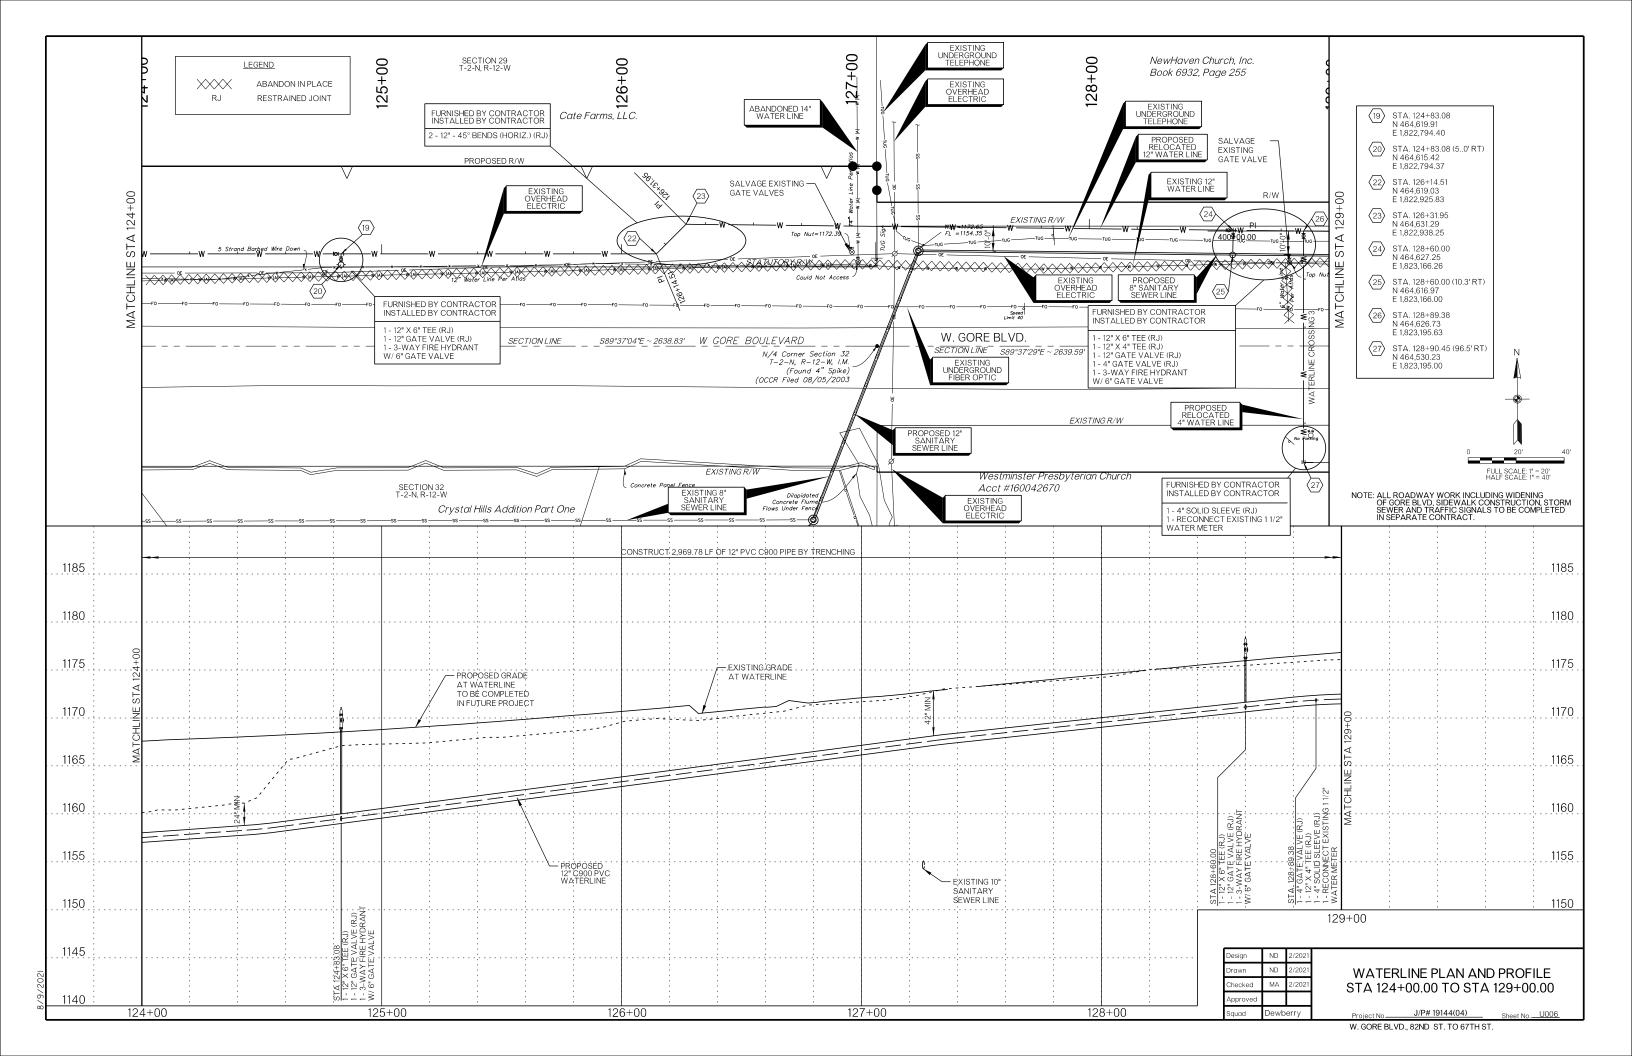


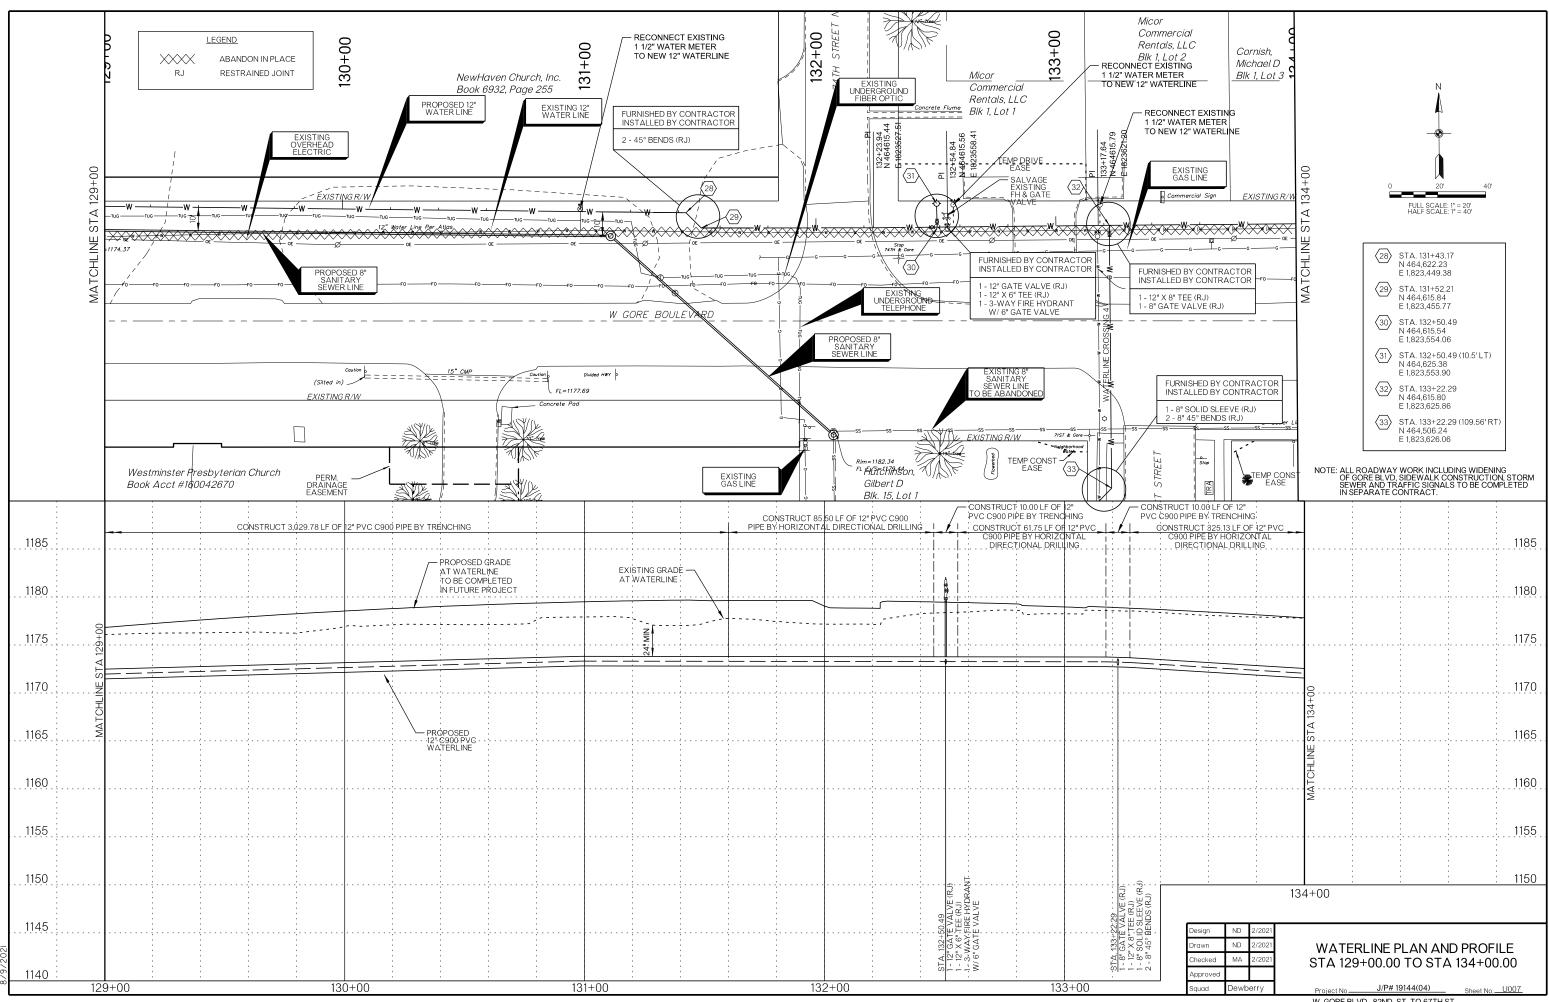


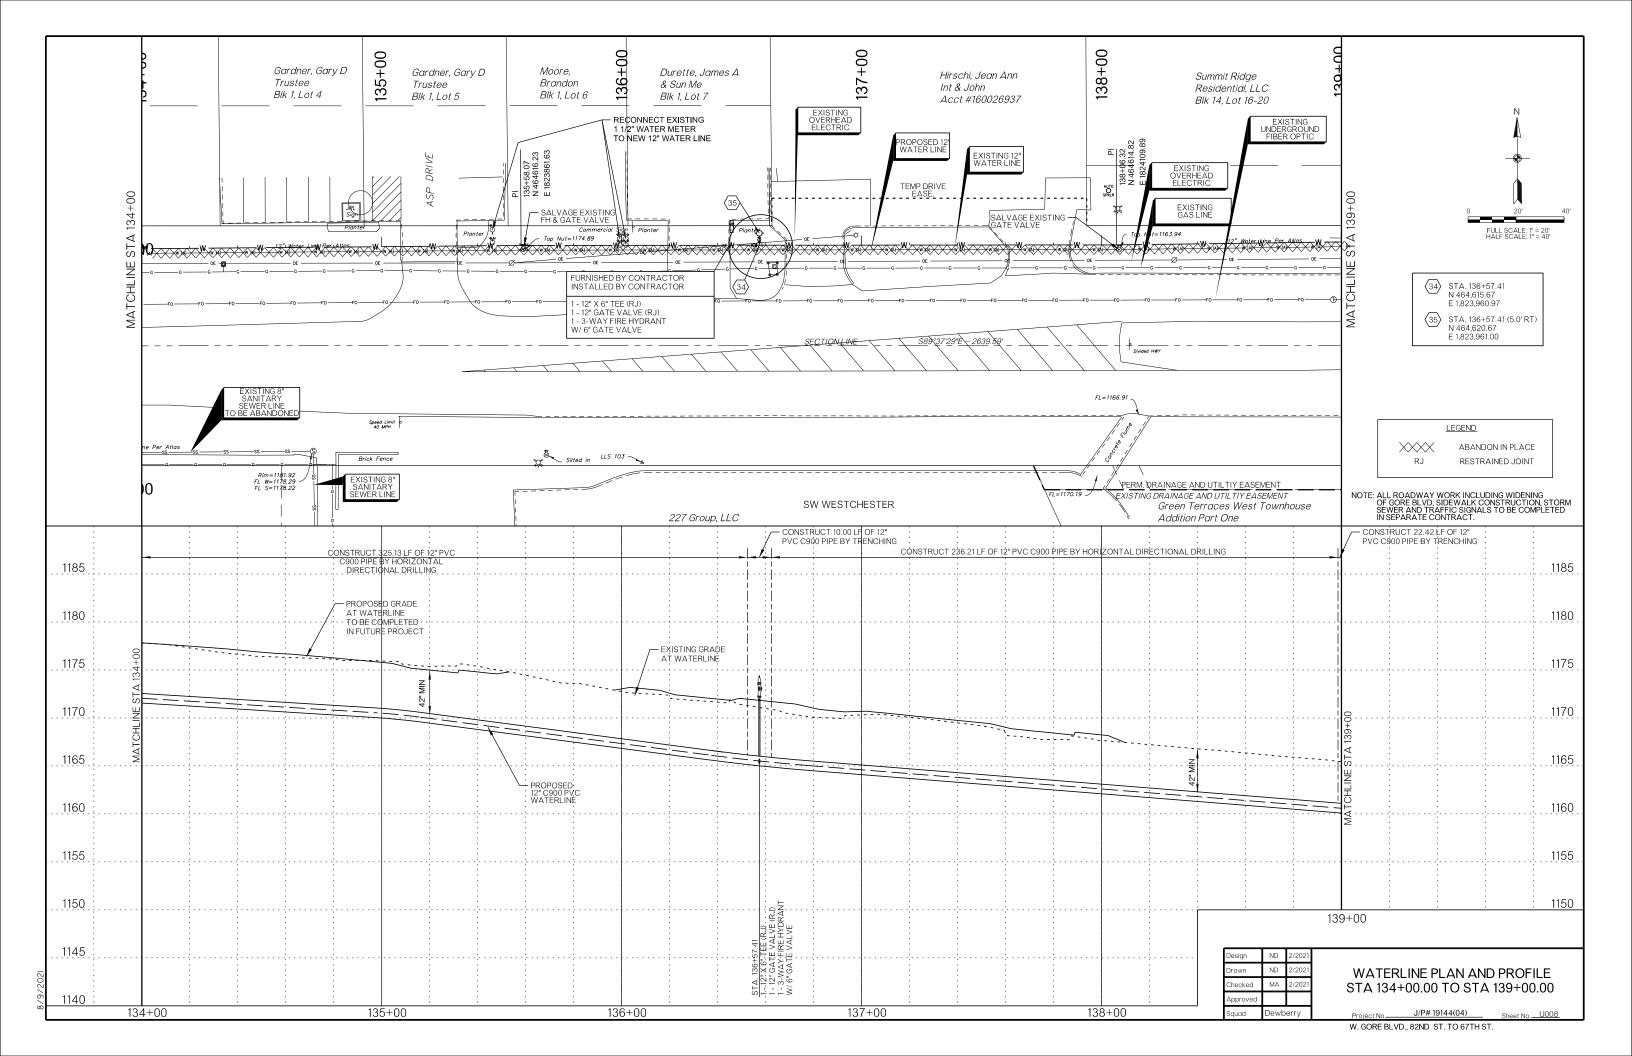


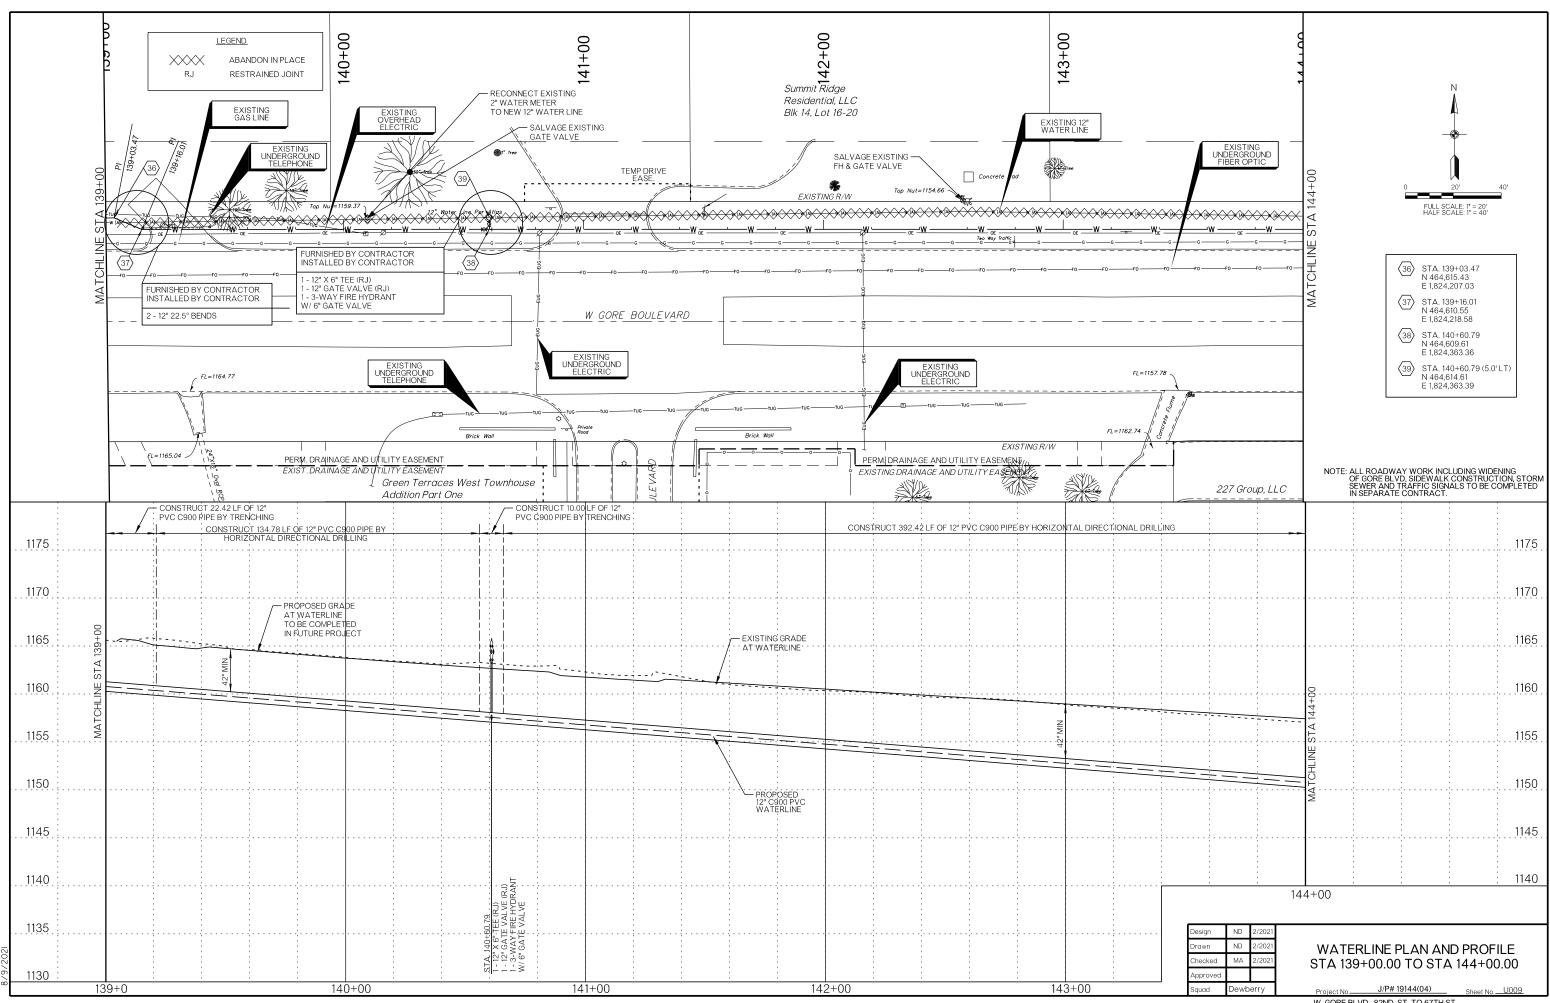

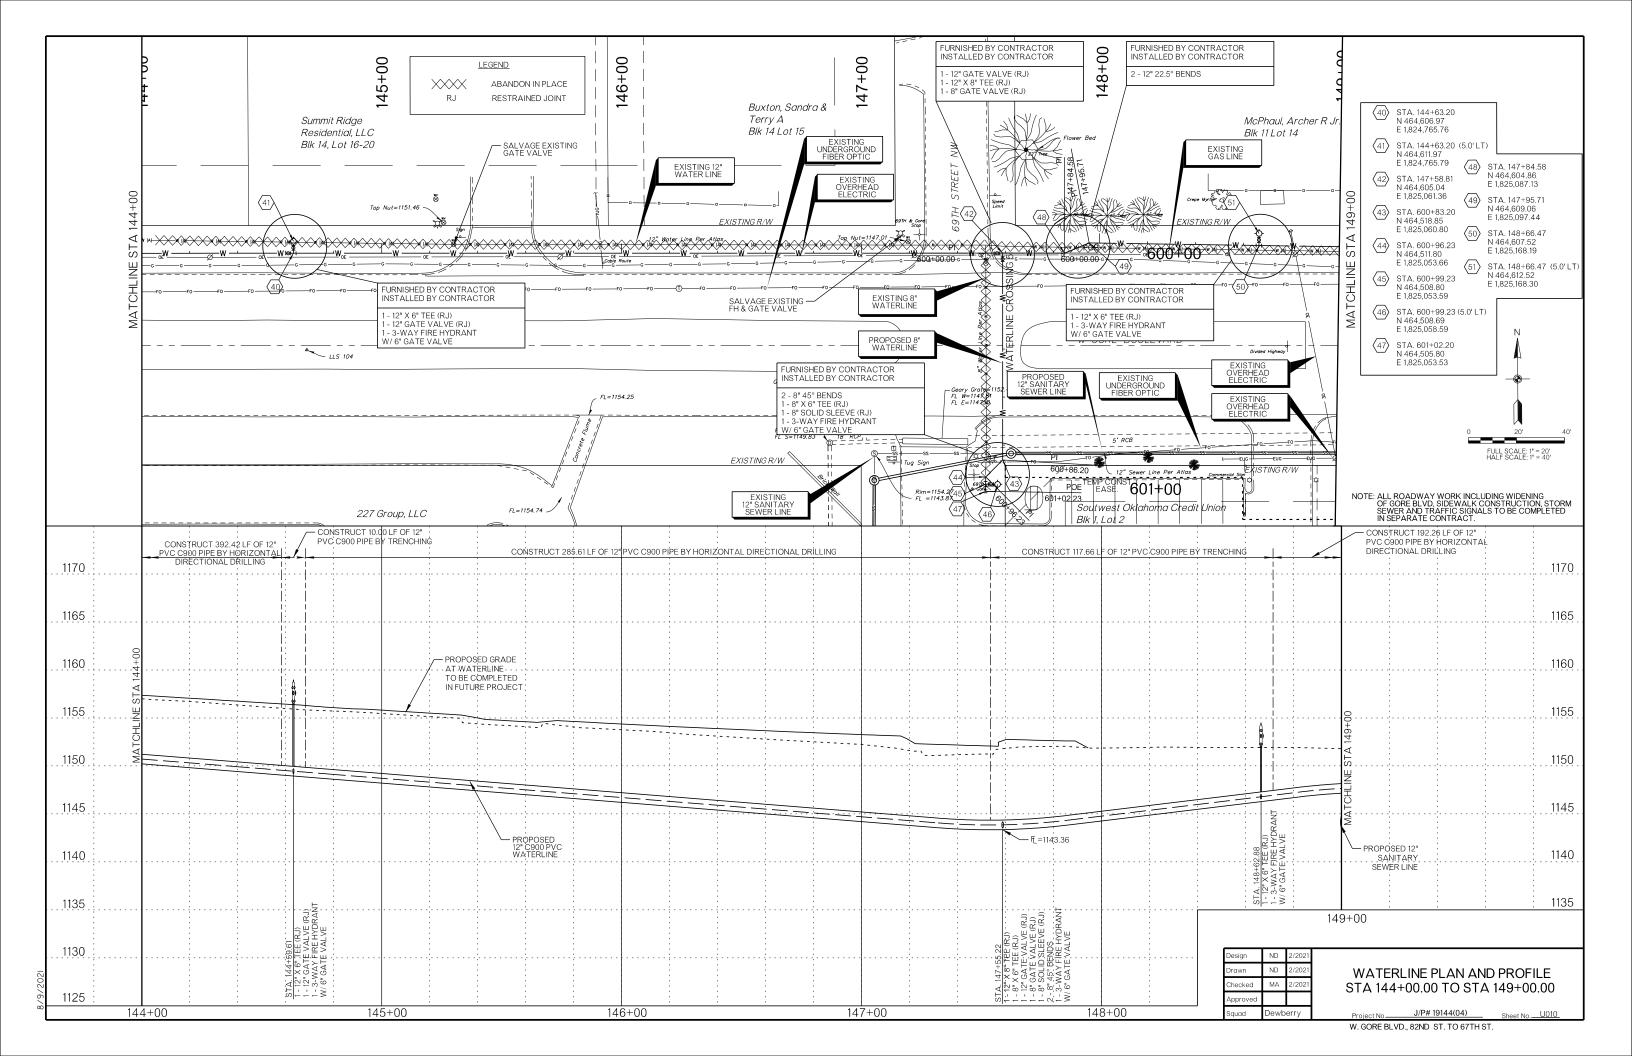


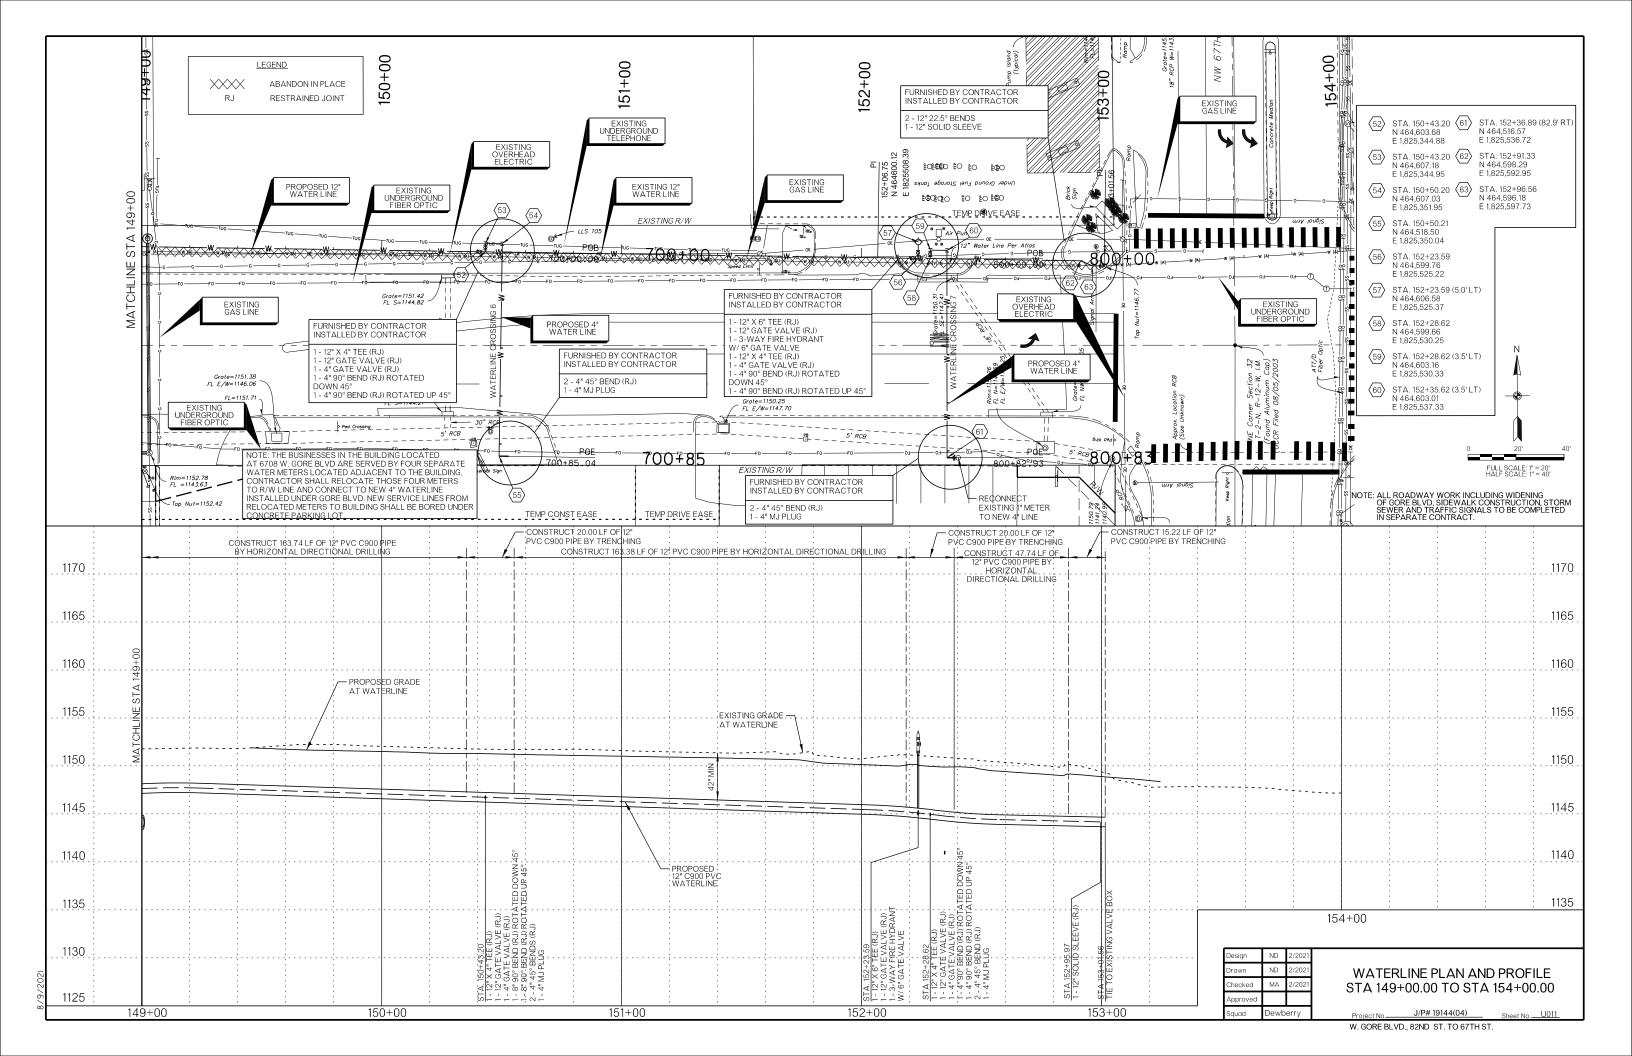


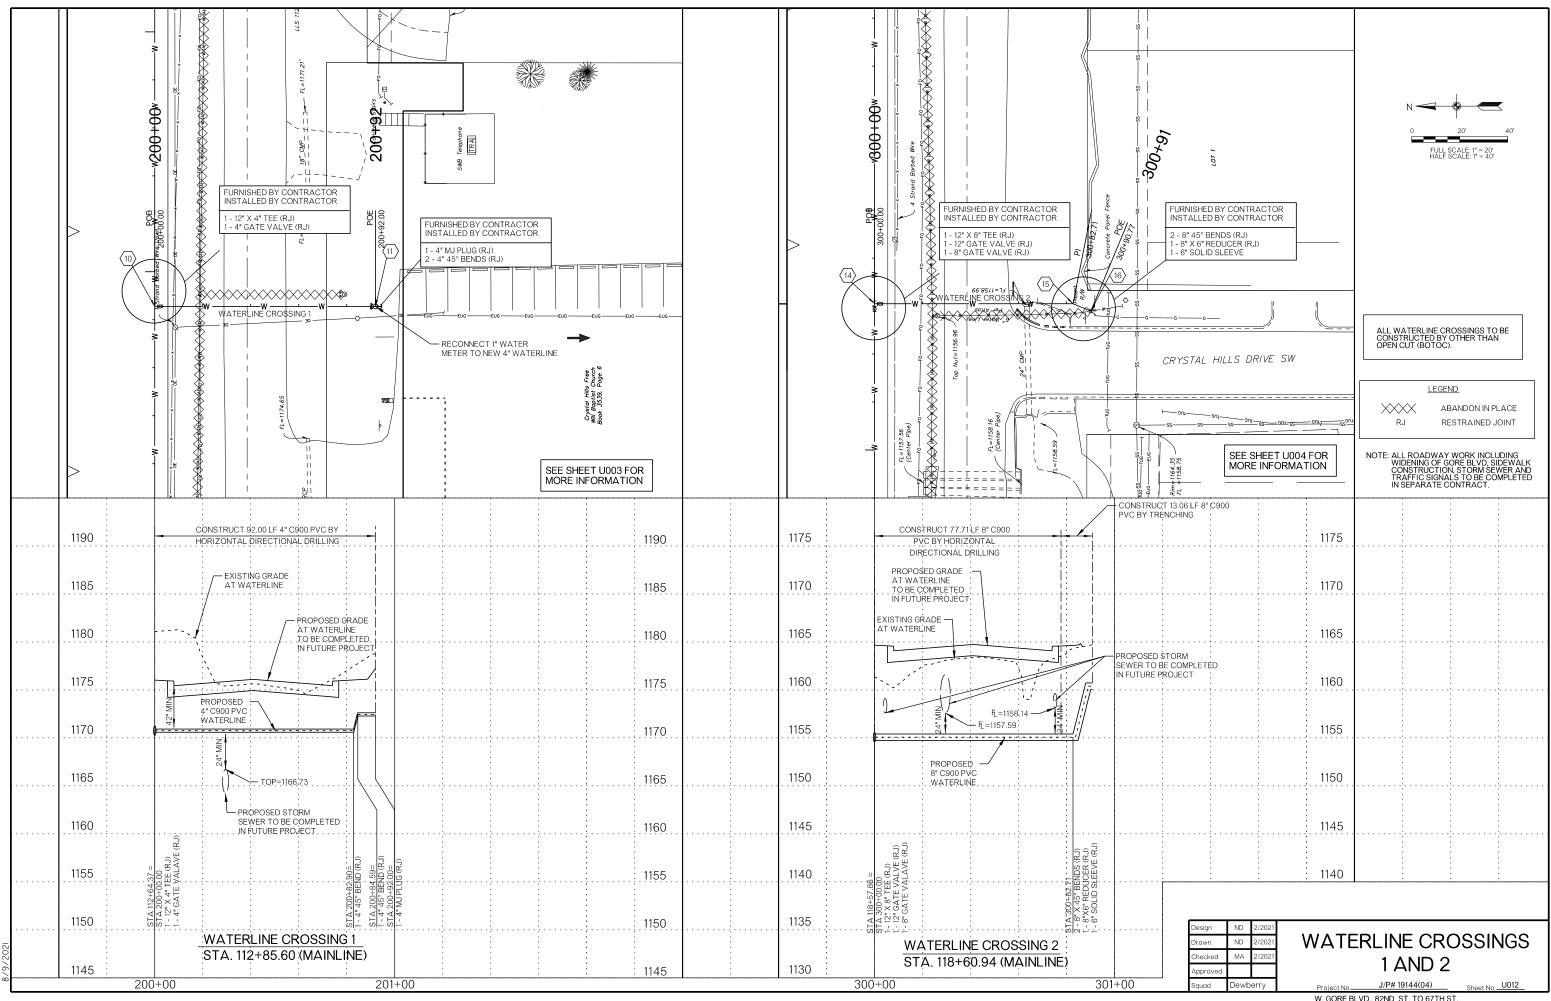

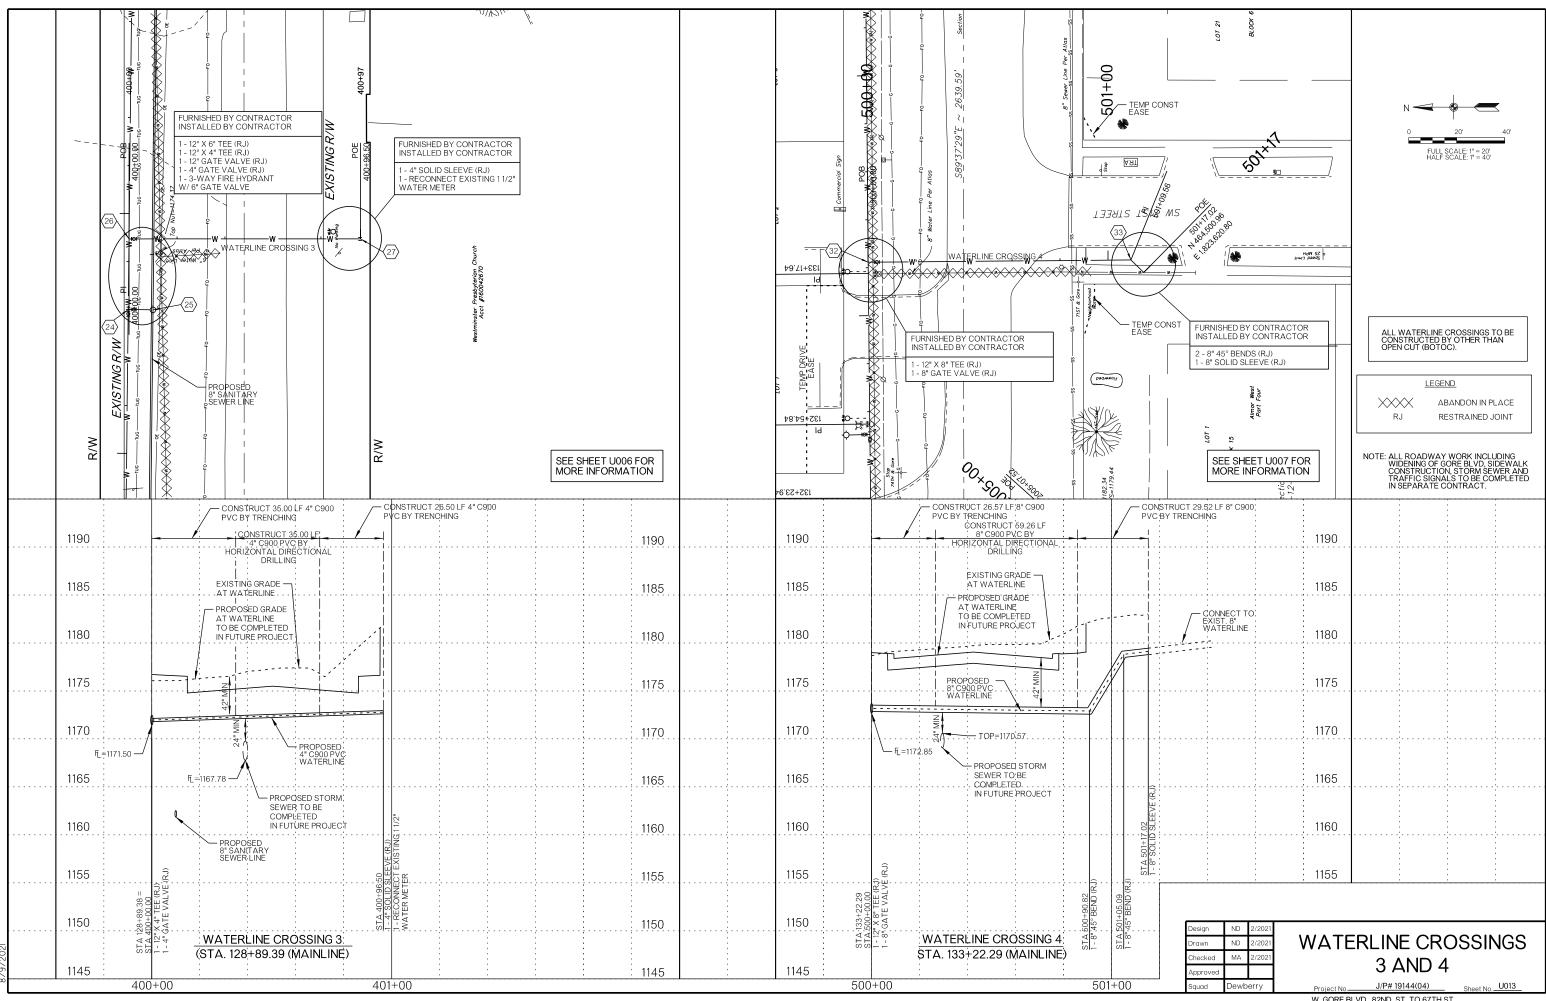

Design	ND	2/2021
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Checked	MA	2/2021
Approved		
Squad	Dewb	erry

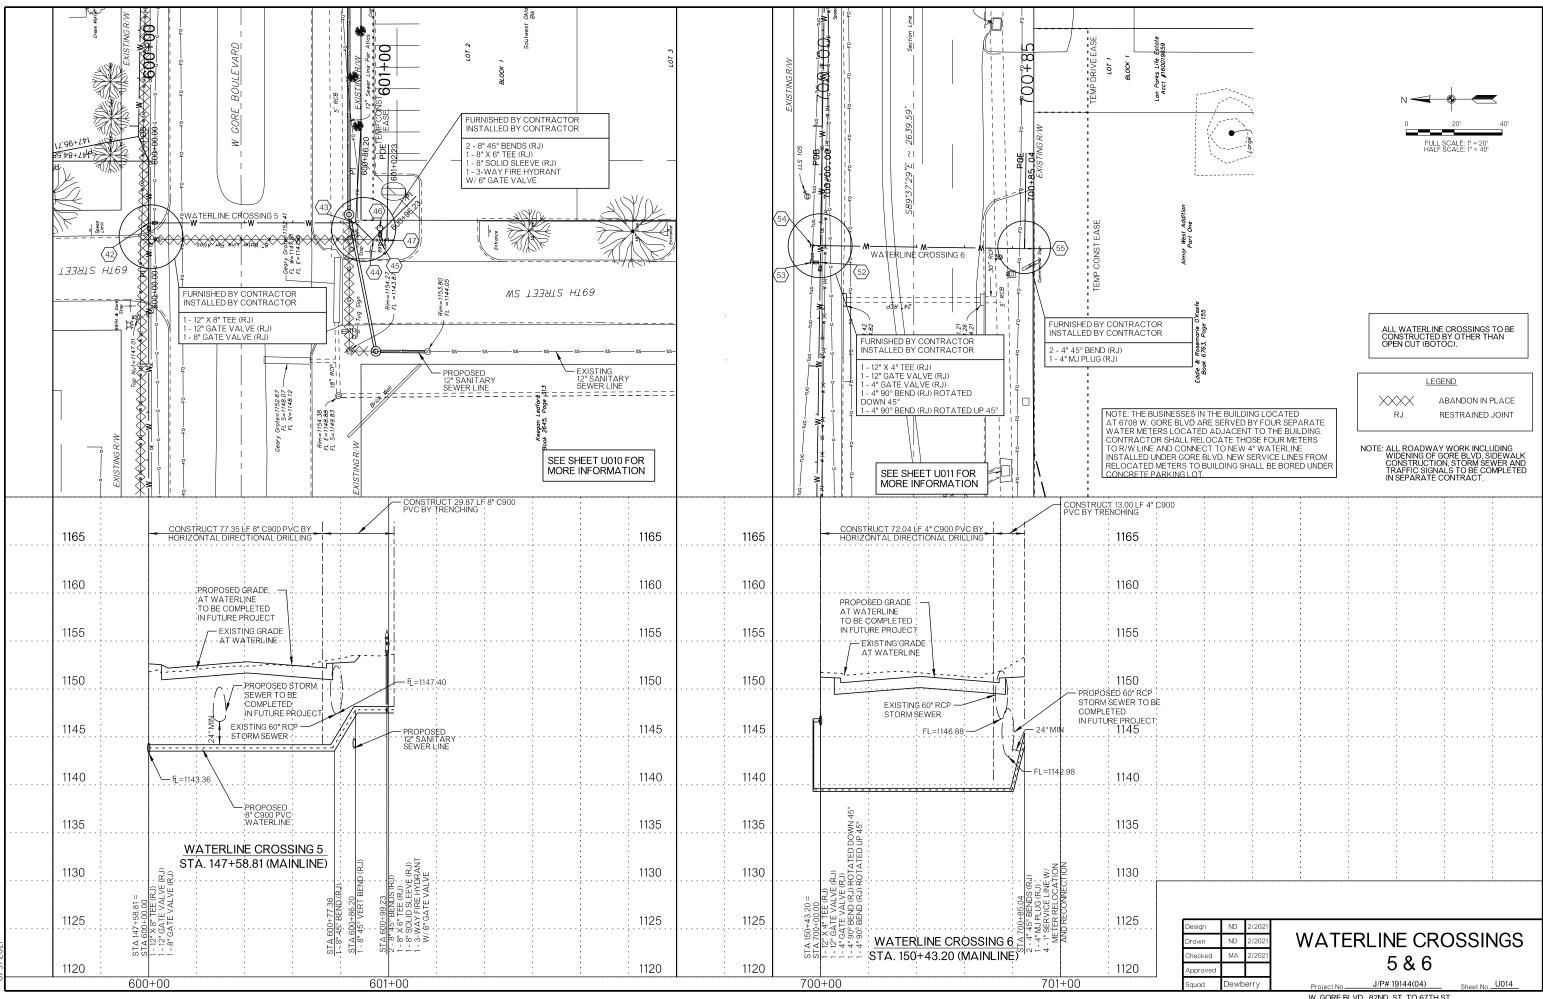


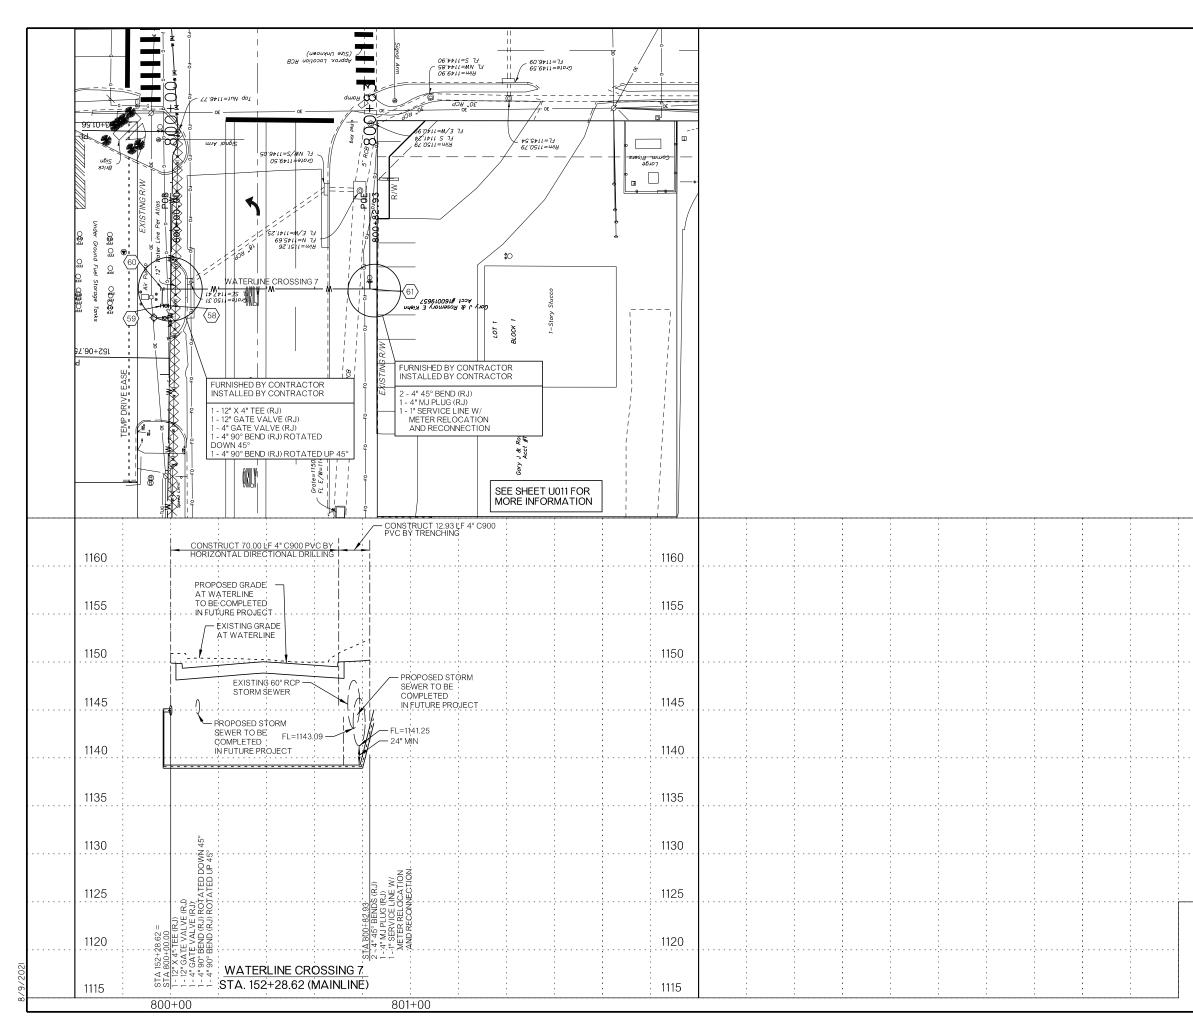

	N $20'$ $40'$ FULL SCALE: 1" = 20' HALF SCALE: 1" = 40'
	ALL WATERLINE CROSSINGS TO BE CONSTRUCTED BY OTHER THAN OPEN CUT (BOTOC). LEGEND XXXX ABANDON IN PLACE RJ RESTRAINED JOINT NOTE: ALL ROADWAY WORK INCLUDING
	NOTE: ALL ROADWAY WORK INCLUDING WIDENING OF GORE BLVD, SIDEWALK CONSTRUCTION, STORM SEWER AND TRAFFIC SIGNALS TO BE COMPLETED IN SEPARATE CONTRACT.
DesignND2/20DrawnND2/20CheckedMA2/20Approved	

J/P# 19144(04) Sheet No. U015 Proiect No W. GORE BLVD., 82ND ST. TO 67TH ST.

Gauad Dewberry

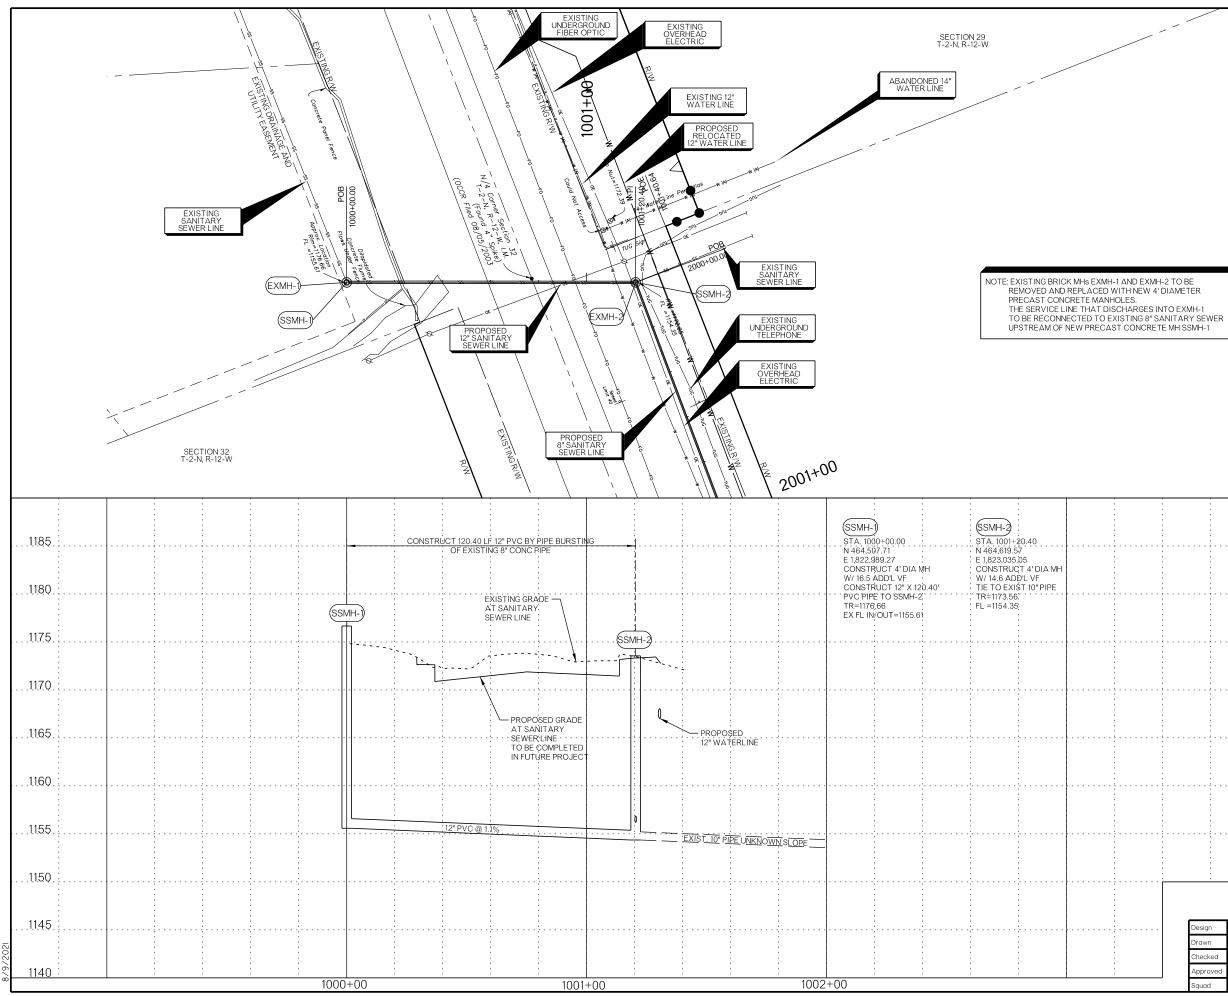


FULL SCALE: 1" = 20 HALF SCALE: 1" = 40


	NOTE: ALL ROADWAY WORK INCLUDING WIDEN OF GORE BLVD, SIDEWALK CONSTRUCTI SEWER AND TRAFFIC SIGNALS TO BE CO IN SEPARATE CONTRACT.	ING DN, STORM MPLETED
		1
		1185
		1180
 		1175
 		1170
 		1165
 		1160
 		1155
•		: 1150

Squad	Dewb	erry
Approved		
Checked	MA	2/2021
Drawn	ND	2/2021
Design	ND	2/2021

## SANITARY SEWER 1

J/P# 19144(04) Sheet No. U016 Project No W. GORE BLVD., 82ND ST. TO 67TH ST.

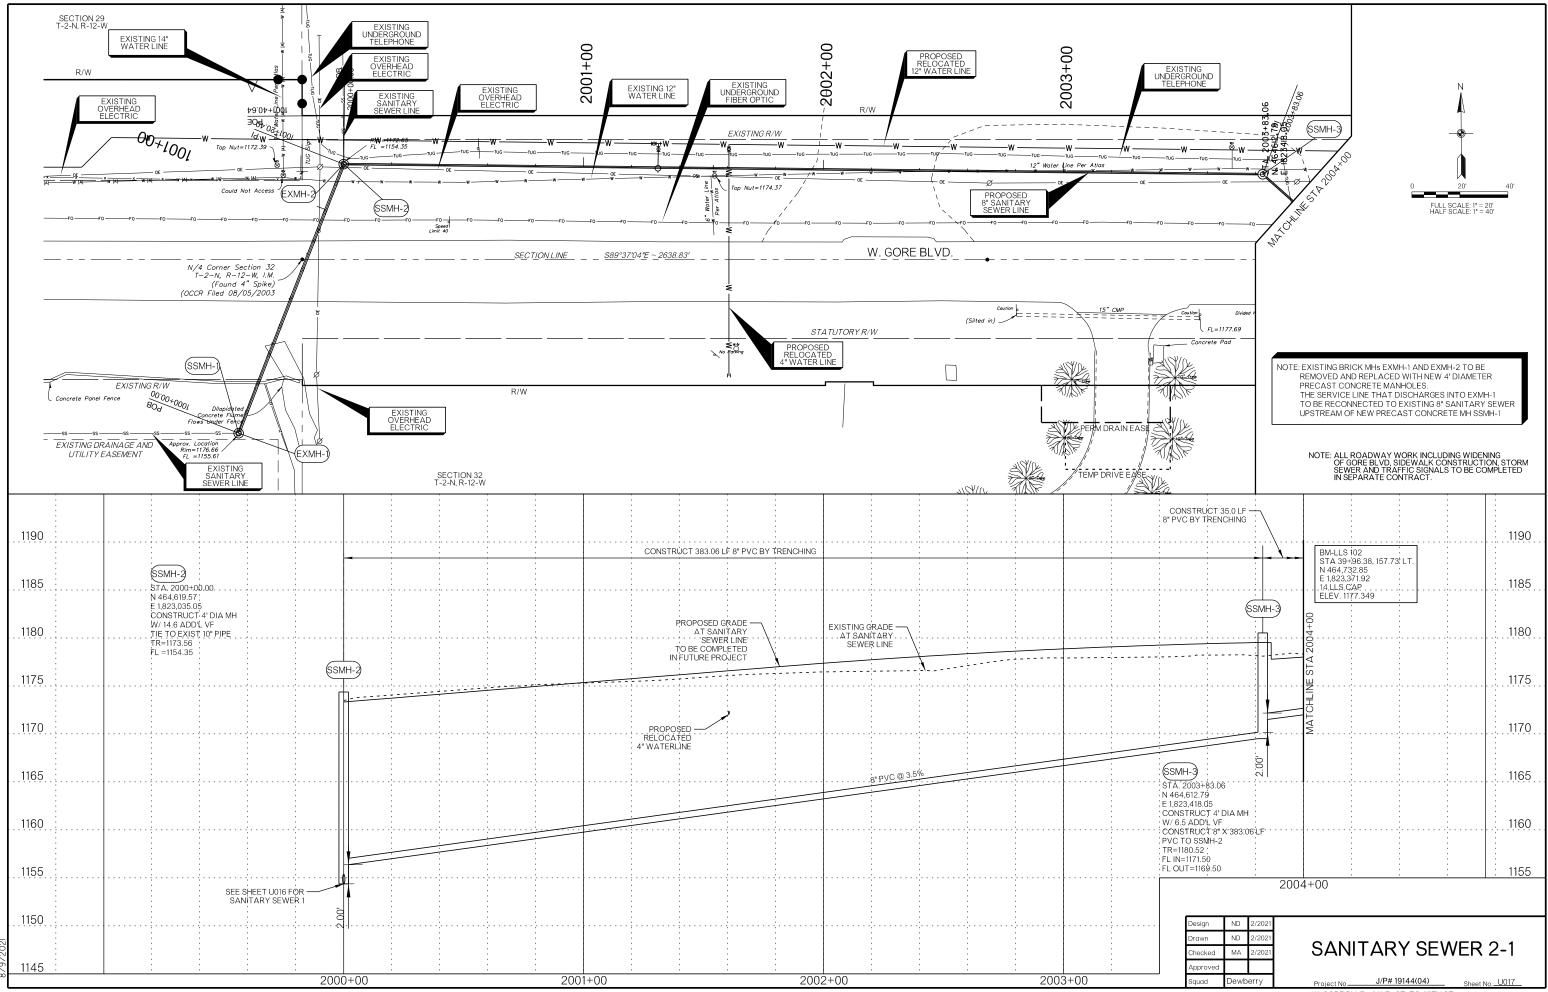

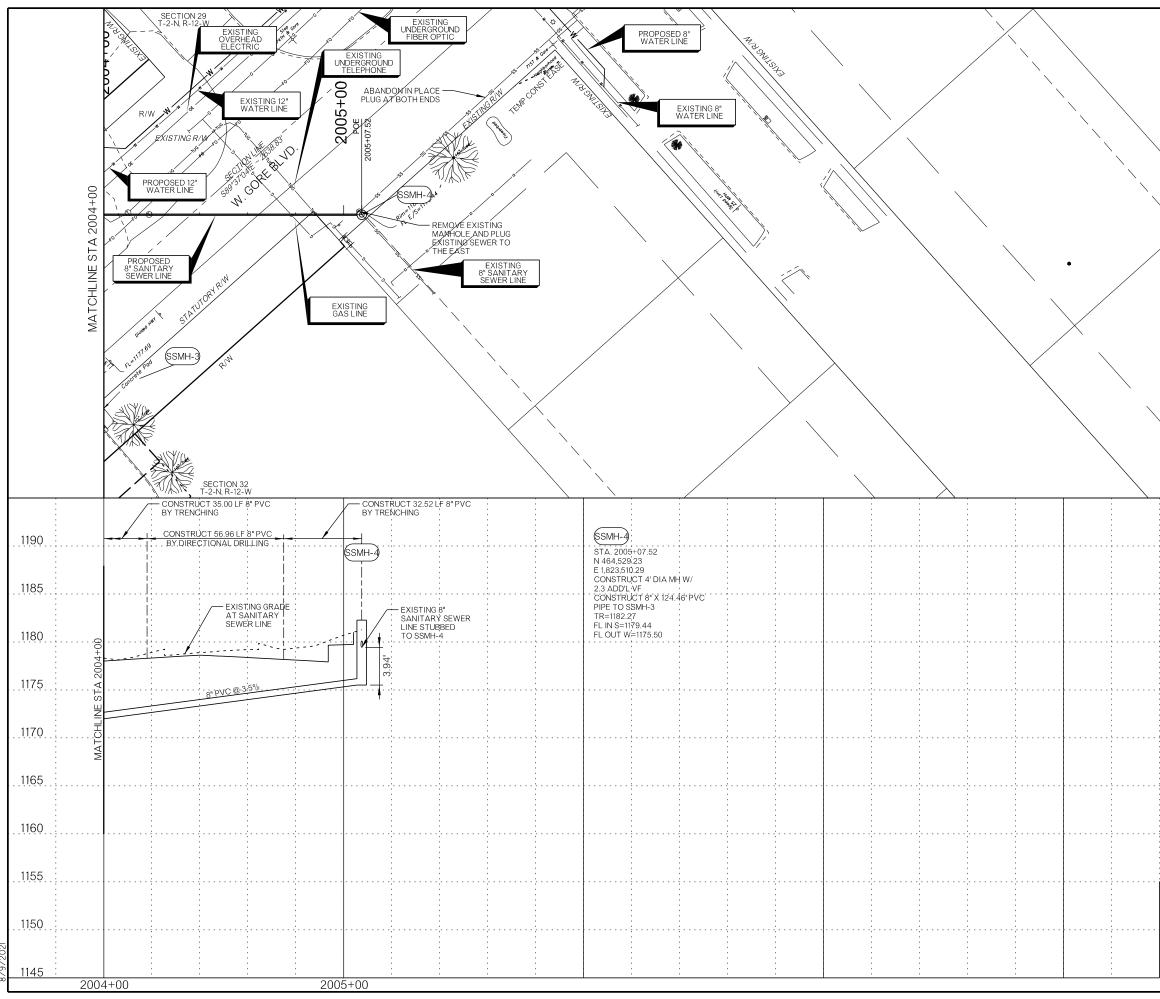


			0 FULL	20' SCALE:  * = 20 SCALE: 1* = 40	40'
	NOTE: ALL OF G SEW IN SE	ROADWAY W ORE BLVD, S ER AND TRAF PARATE CO	/ORK INCLUE IDEWALK CO FFIC SIGNALS NTRACT.	ING WIDENIN NSTRUCTION TO BE COMP	G I, STORM LETED
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· · · · · ·					
 · · · · · ·					1180
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	 				1175
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Design	ND	2/2021	
Drawn	NE	2/2021	
Checked	MZ	4 2/2021	
Approved	ł		
Squad	Dev	Dewberry	

## SANITARY SEWER 2-2

 Project No.
 J/P# 19144(04)
 Sheet No.
 U018

 W. GORE BLVD., 82ND ST. TO 67TH ST.

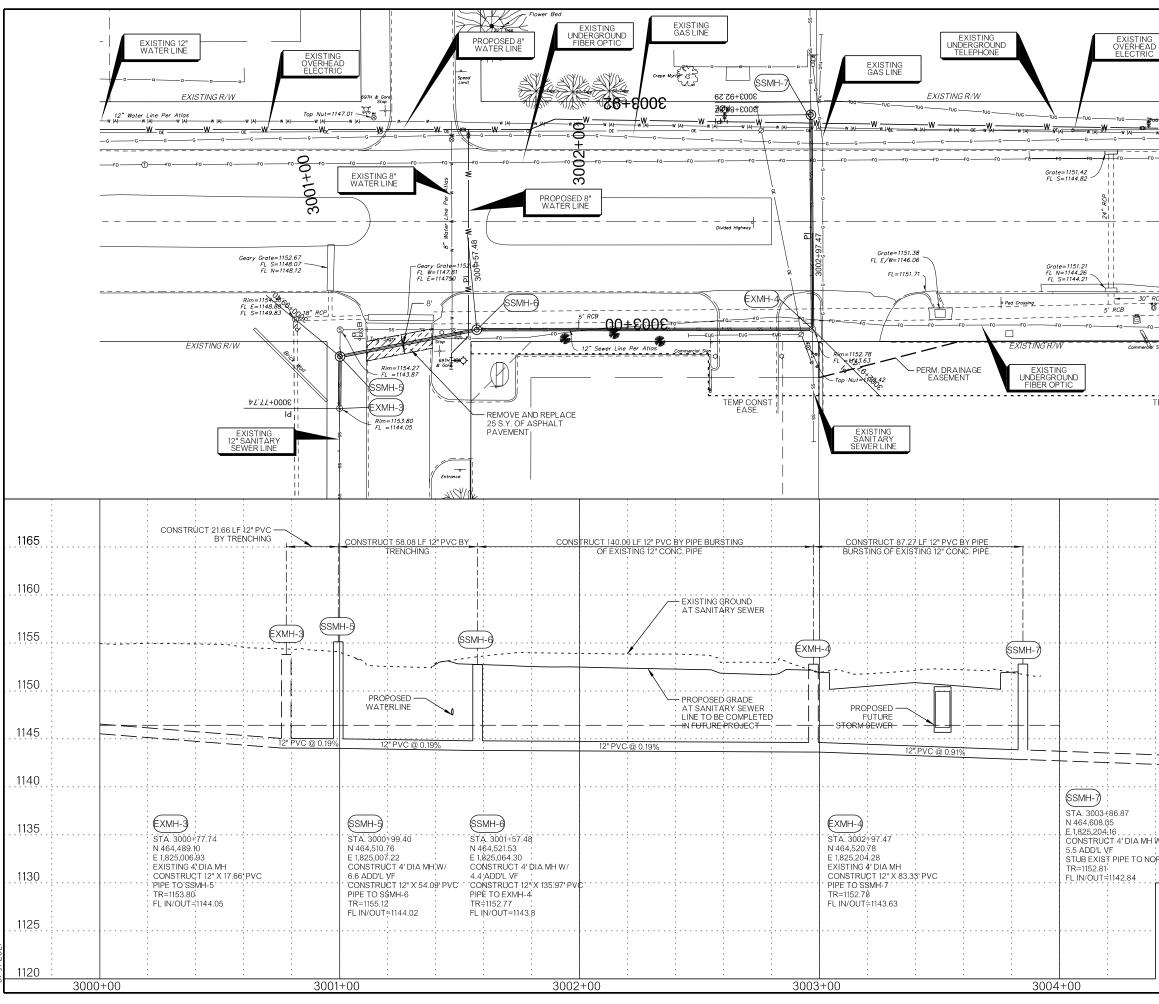

ULS 105 TUG	
NATER LINE	0 20' 40' FULL SCALE:  * = 20' HALF SCALE:  * = 40'
<u>↓</u>	HALF SCALE: 1* = 40'
<u>s</u>	
7	
ign	
EMP CONST EASE.	
	NOTE: ALL ROADWAY WORK INCLUDING WIDENING OF GORE BLVD, SIDEWALK CONSTRUCTION, STORM SEWER AND TRAFFIC SIGNALS TO BE COMPLETED IN SEPARATE CONTRACT.
	1165
	1160
	1155
	1150
	1140
//	

Design	ND	2/2021	
Drawn	ND	2/2021	
Checked	MA	2/2021	
Approved			
Squad	Dewberry		

## SANITARY SEWER 3

 Project No.
 J/P# 19144(04)
 Sheet No.
 U019

 W. GORE BLVD., 82ND ST. TO 67TH ST.